

BASIS OF BEARING

[illegible]

BENCHMARK

STONE™ 74 20K 2 1/2" -
LA 1.00E-35 55.96.53.5875
15-6176E-11 1110.36.722E W (A) 760
HEC- 2.99E-304.8E1 (NAVO08)

15-6176E-11 1110.36.722E W (A) 760
HEC- 2.99E-304.8E1 (NAVO08)

REFERENCE: ARLO, CAP. 27, DRA. SET IN CONC. 85 FT. NORTH-EAST OF
 THE SOUTH 1/4-CORNER OF SEC. 35, T. 21 N., R. 16 W. AND "THE
 INTERSECTION OF STATE RD. 62 AND 60TH RD." SW-1/4 SEC. 30 IN 1955.
 T15S 1034E.

SEWER CONSTRUCTION NOTES


- [illegible]

WATER CONSTRUCTION NOTES


- ① INSTAL. 8" P.C. PIPE C-455 150 ALLEYS 300 OF A.W.W.A. C-300
- ② INSTAL. 1" T.E. MOUNT ASSESSOR V-73
- ③ A.W.C. SINKING DETAIL NO. 302
- ④ INSTAL. 8" CAFE VALVE V-4-255
- ⑤ INSTAL. 11-255 BENG
- ⑥ INSTAL. 11-255 BENG

- ⑧ INSTALL $b^* \times b^* \times b^*$ lib
- ⑨ INSTALL $b^* \times b^* \times b^* \times b^*$ CPGAS


- ⑬ INSTALL 1" DIA. TIE BARS AT 3'-0" VERTICAL MEET-
ING OF DECK ON SHELL DUE

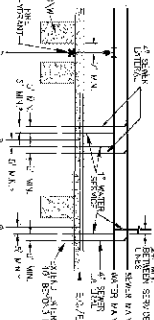


TYPICAL WATER AND S8 LATERALS
N.T.S.

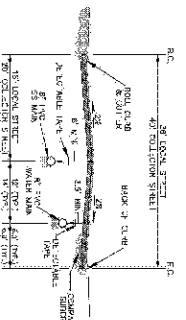

TYPICAL WATER AND SS MAIN LINE SECTION

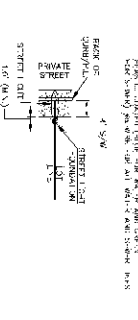

NOTE:
IN LOCATIONS WHERE LIGHT POLE IS NOT
ADJUNCT TO A STREET, FACT OF POLE TO
BE 3' FROM BACK OF CURB.

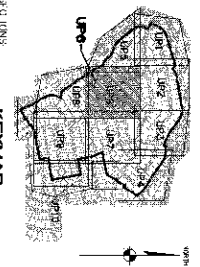

KEYMAP
N.T.S.

LEGEND

- | | |
|-----|---------------|
| 120 | CO- WOMAN |
| --- | THOR - CR WA |
| --- | --- |
| 126 | 5TH TR 4 MP T |

MAILED


- 3/4" WATER
W/ 1" WALKER
FIRE, 11/10/64

⑤

- SANITARY S
4th -YD SEW
STLB. AND C

STORM DEF

- STOPN DRN
STORM DRN
STORM DRN

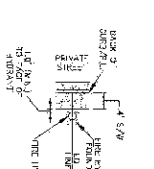

FIRE HYDRANT LOCATIONS

GEOTECHNICAL

100

FEMA FLOOD ZON
FEMA MAP PANEL NO. 040508 Z025
MAP DATE: 05. 20, 2000
PRIVATE & OF AREA 2 LHS WITHIN AN
DESIGNATED AS A FEMA FLOOD ZONE

DISCLAIMER NOTE

UTILITY LOCATIONS & WORK
ZONES ARE APPROXIMATE
ONLY. IT SHALL BE THE
CONTRACTOR'S RESPONSIBILITY
TO OBTAIN THE EXACT
LOCATION AND MARKING.

SELECTION OF ALL EIGHTS
JOURNALISM OF CHINA
HEADLINE IS FROM TO
GOVERNMENT'S POSITION,
NO REPRESENTATION IS MADE
-AT ALL EASTERN JETTES
ARE STRONG -FROM THE

—CUB. MON

RHODES HOMES ARIZONA, LLC
GOLDEN VALLEY RANCH

AREA 2 PHASE A
UTILITY PLAN 6









Stanley Consultants INC.

5620 N. Lander Avenue, Suite 700
Las Vegas, Nevada 89119
(702) 369-9396 Fax (702) 369-9793
www.sconeysgroup.com

SCALE (-) 1"=40'
SCALE (+) N/A
DRAWN BY GA
CHECKED BY SH/DE



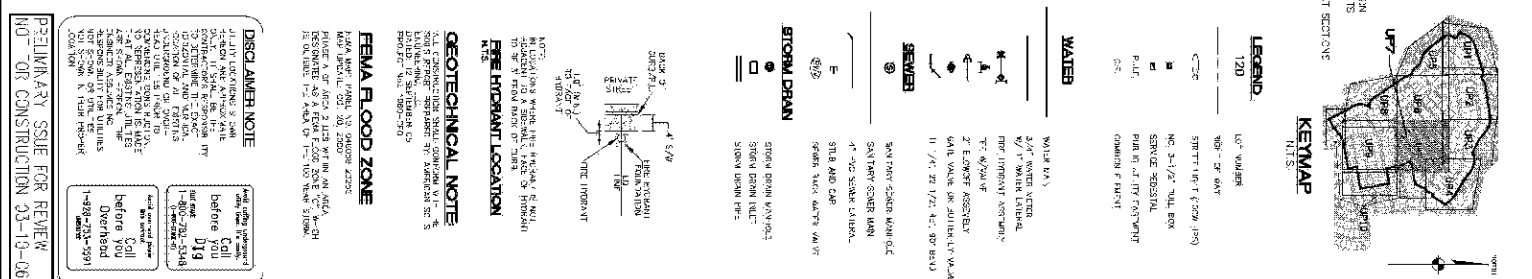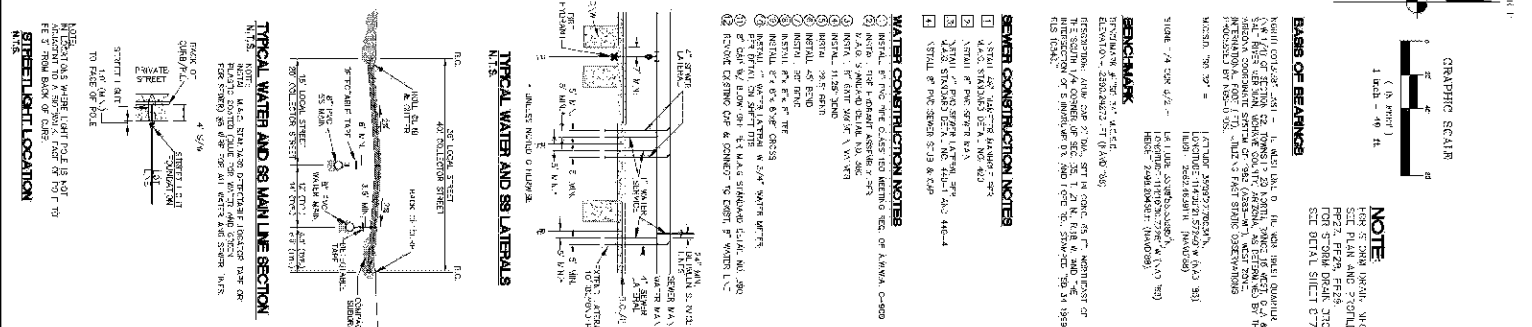

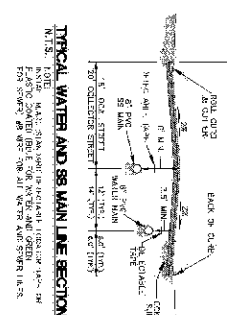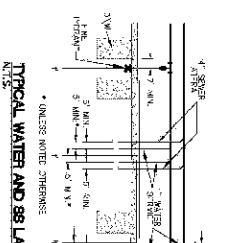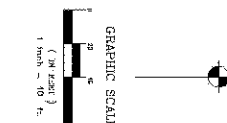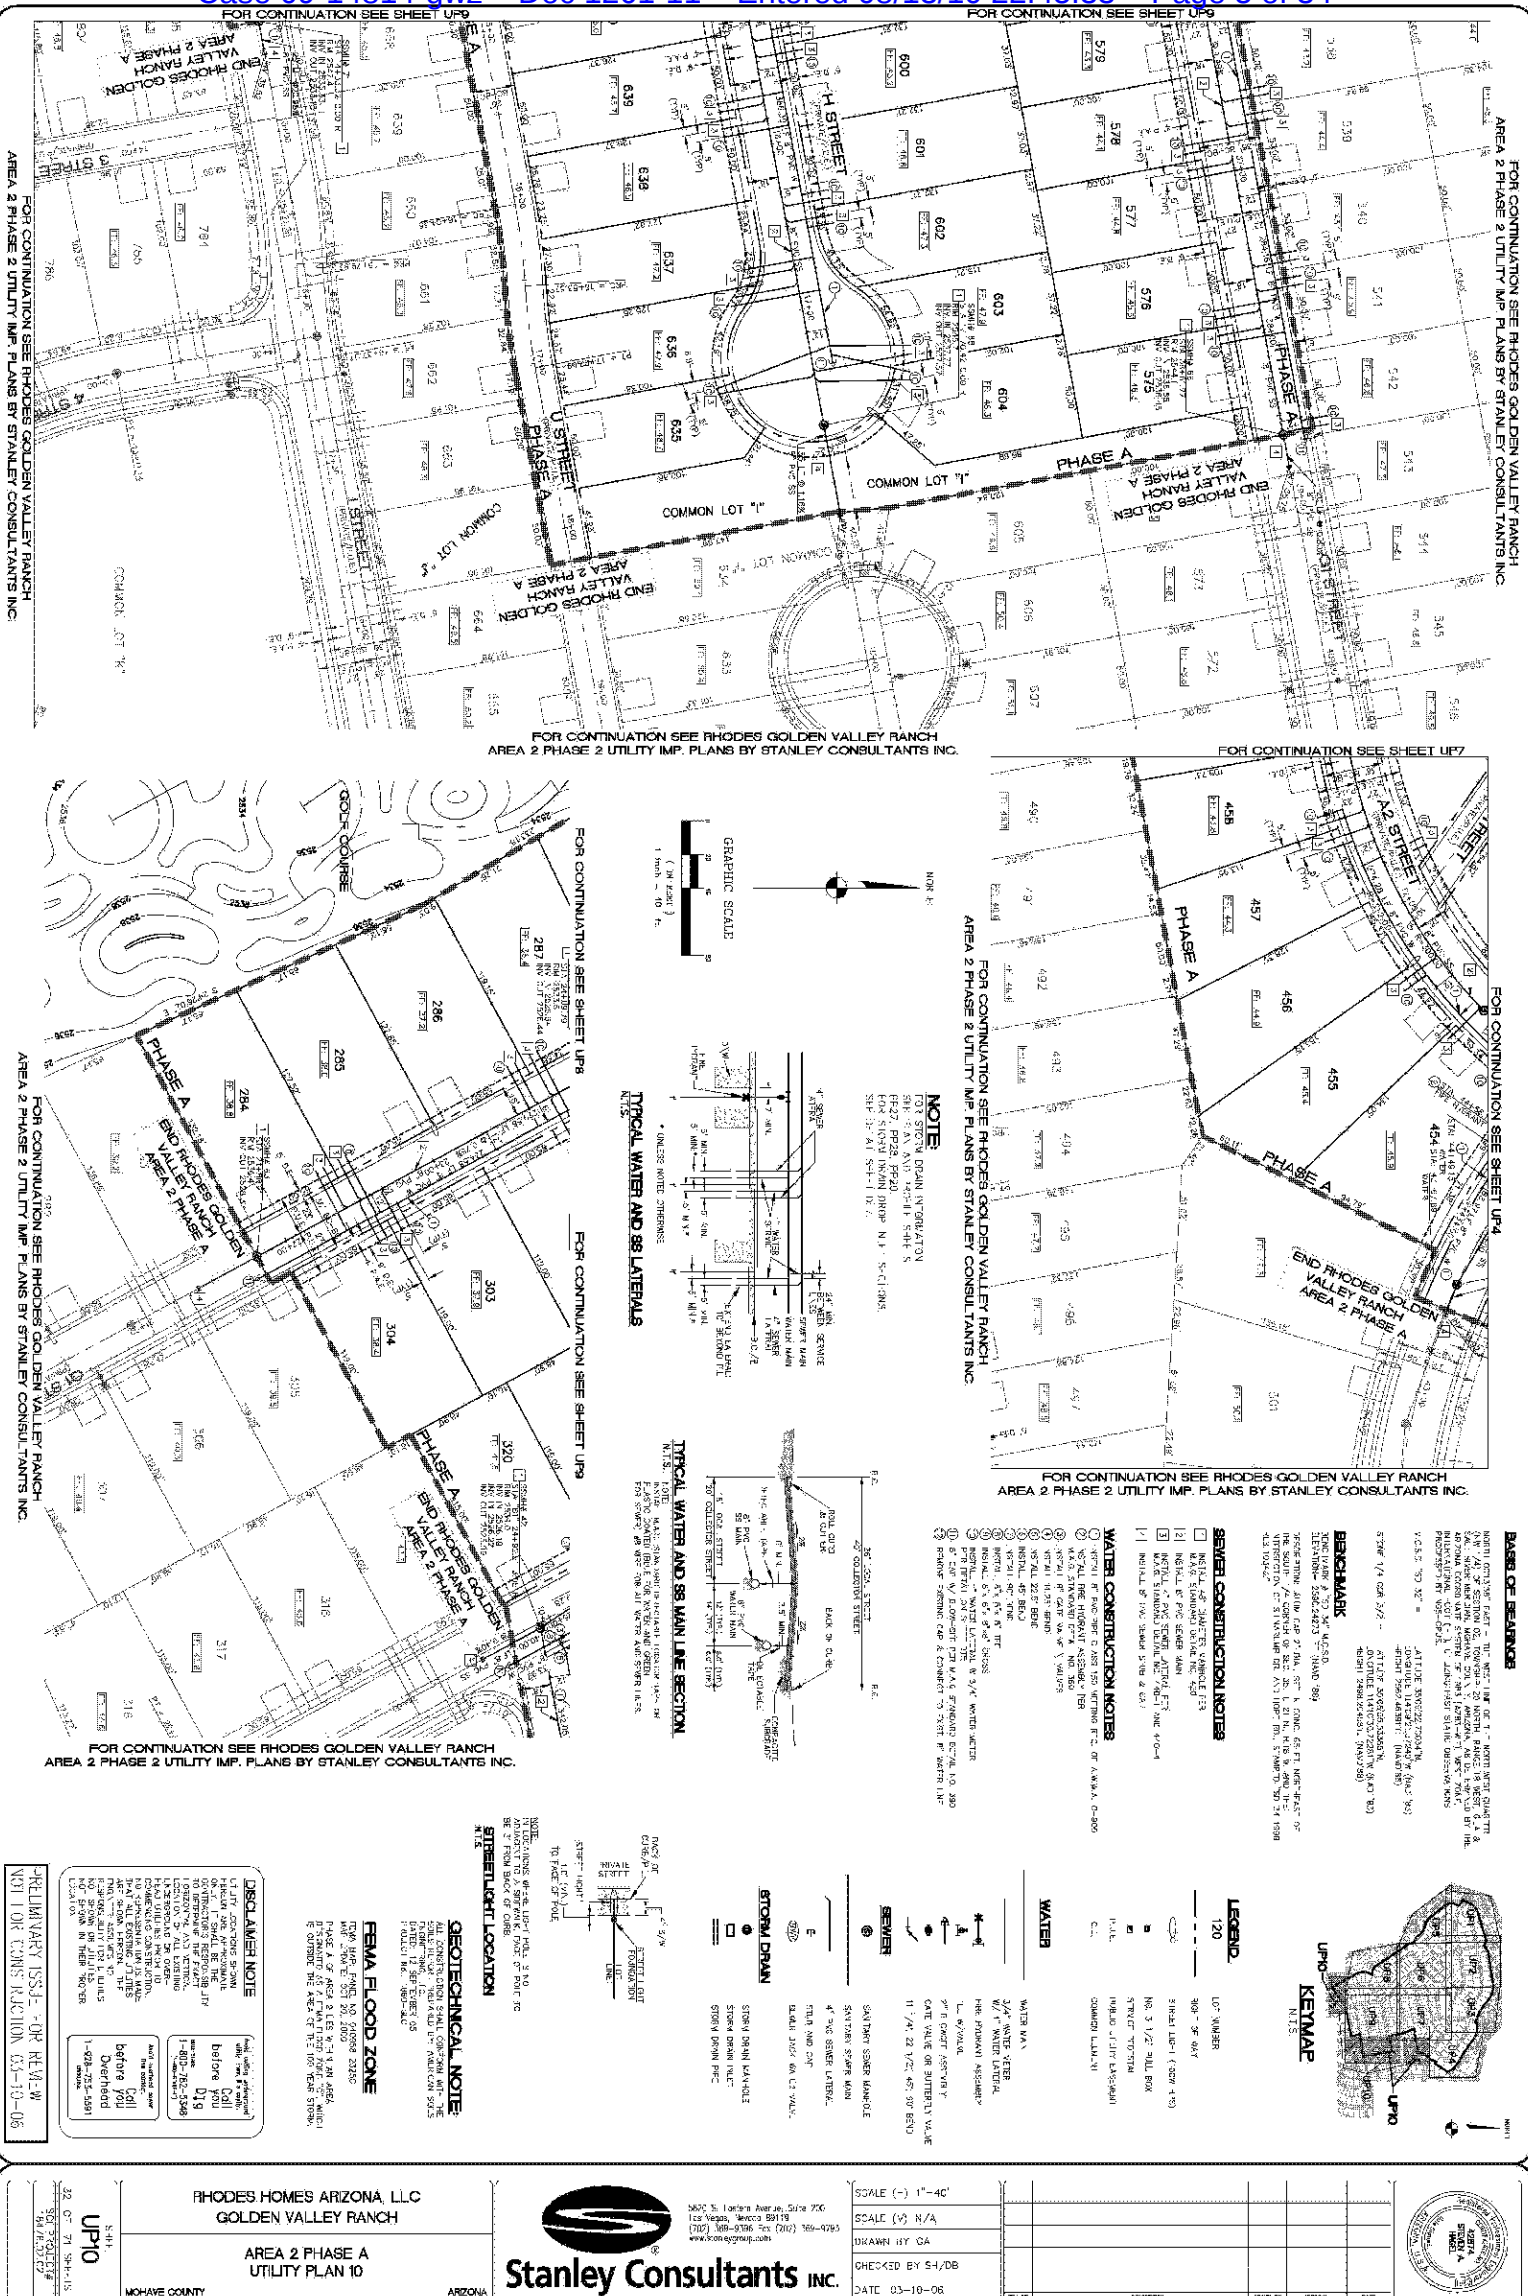



NOTE:
FOR STORM DRAIN INFORMATION, SEE SHEET UP10.
FOR SEWER INFORMATION, SEE SHEET UP10.
FOR WATER MAIN INFORMATION, SEE SHEET UP10.

- SEWER CONSTRUCTION NOTES**
1. ALL SEWER LINES SHALL BE 12" DIA. UNLESS NOTED OTHERWISE.
 2. ALL SEWER LINES SHALL BE 40' MIN. DEPTH UNLESS NOTED OTHERWISE.
 3. ALL SEWER LINES SHALL BE 10' MIN. SPAN UNLESS NOTED OTHERWISE.
 4. ALL SEWER LINES SHALL BE 10' MIN. SPAN UNLESS NOTED OTHERWISE.
 5. ALL SEWER LINES SHALL BE 10' MIN. SPAN UNLESS NOTED OTHERWISE.
 6. ALL SEWER LINES SHALL BE 10' MIN. SPAN UNLESS NOTED OTHERWISE.
 7. ALL SEWER LINES SHALL BE 10' MIN. SPAN UNLESS NOTED OTHERWISE.
 8. ALL SEWER LINES SHALL BE 10' MIN. SPAN UNLESS NOTED OTHERWISE.
 9. ALL SEWER LINES SHALL BE 10' MIN. SPAN UNLESS NOTED OTHERWISE.
 10. ALL SEWER LINES SHALL BE 10' MIN. SPAN UNLESS NOTED OTHERWISE.

- WATER CONSTRUCTION NOTES**
1. ALL WATER LINES SHALL BE 12" DIA. UNLESS NOTED OTHERWISE.
 2. ALL WATER LINES SHALL BE 40' MIN. DEPTH UNLESS NOTED OTHERWISE.
 3. ALL WATER LINES SHALL BE 10' MIN. SPAN UNLESS NOTED OTHERWISE.
 4. ALL WATER LINES SHALL BE 10' MIN. SPAN UNLESS NOTED OTHERWISE.
 5. ALL WATER LINES SHALL BE 10' MIN. SPAN UNLESS NOTED OTHERWISE.
 6. ALL WATER LINES SHALL BE 10' MIN. SPAN UNLESS NOTED OTHERWISE.
 7. ALL WATER LINES SHALL BE 10' MIN. SPAN UNLESS NOTED OTHERWISE.
 8. ALL WATER LINES SHALL BE 10' MIN. SPAN UNLESS NOTED OTHERWISE.
 9. ALL WATER LINES SHALL BE 10' MIN. SPAN UNLESS NOTED OTHERWISE.
 10. ALL WATER LINES SHALL BE 10' MIN. SPAN UNLESS NOTED OTHERWISE.

LEGEND

120' NUMBER
120' NUMBER
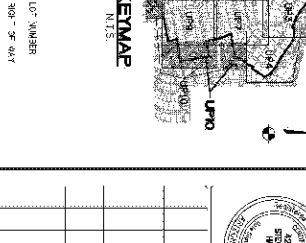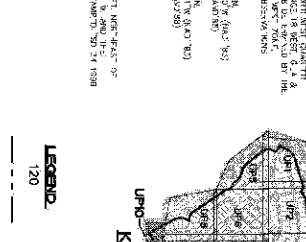

DISCLAIMER NOTE

THIS DOCUMENT IS THE PROPERTY OF STANLEY CONSULTANTS INC. AND IS NOT TO BE REPRODUCED OR TRANSMITTED IN ANY FORM OR BY ANY MEANS, ELECTRONIC OR MECHANICAL, INCLUDING PHOTOCOPYING, RECORDING, OR BY ANY INFORMATION STORAGE AND RETRIEVAL SYSTEM, WITHOUT THE WRITTEN PERMISSION OF STANLEY CONSULTANTS INC.

PRELIMINARY ISSUE - FOR REVIEW






NOT FOR CONSTRUCTION

GEOTECHNICAL NOTE

ALL CONSTRUCTION SHALL BE IN ACCORDANCE WITH THE CITY OF PHOENIX STANDARD SPECIFICATIONS FOR WATER AND SEWER LATERALS AND MAIN LINES.

FEMA FLOOD ZONE


PHASE A & B ARE IN FEMA FLOOD ZONE X-1 (1% ANNUAL FLOOD). PHASE C IS IN FEMA FLOOD ZONE X-2 (0.2% ANNUAL FLOOD).

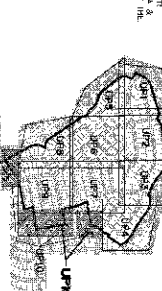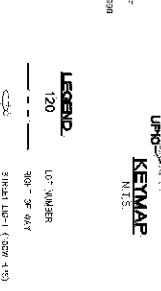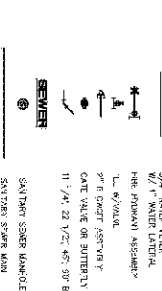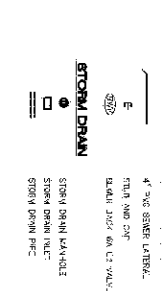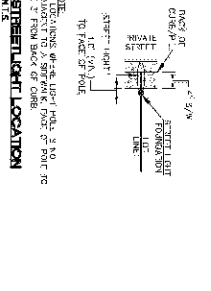



FOR CONTINUATION SEE SHEET SL2

FOR CONTINUATION SEE SHEET SL2

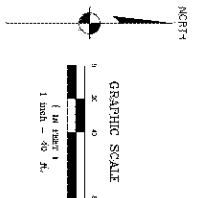

NEW STREETLIGHT SERVICE PEDESTAL CIRCUIT 'A'

STREETLIGHT CIRCUIT 'A' CAPACITY VERIFICATION

STREETLIGHT CIRCUIT 'A' CAPACITY VERIFICATION	120 AMP	150 AMP	200 AMP
1. TOTAL CIRCUIT LENGTH	120 AMP	150 AMP	200 AMP
2. TOTAL CIRCUIT LENGTH	120 AMP	150 AMP	200 AMP
3. TOTAL CIRCUIT LENGTH	120 AMP	150 AMP	200 AMP
4. TOTAL CIRCUIT LENGTH	120 AMP	150 AMP	200 AMP
5. TOTAL CIRCUIT LENGTH	120 AMP	150 AMP	200 AMP
6. TOTAL CIRCUIT LENGTH	120 AMP	150 AMP	200 AMP
7. TOTAL CIRCUIT LENGTH	120 AMP	150 AMP	200 AMP
8. TOTAL CIRCUIT LENGTH	120 AMP	150 AMP	200 AMP
9. TOTAL CIRCUIT LENGTH	120 AMP	150 AMP	200 AMP
10. TOTAL CIRCUIT LENGTH	120 AMP	150 AMP	200 AMP
11. TOTAL CIRCUIT LENGTH	120 AMP	150 AMP	200 AMP
12. TOTAL CIRCUIT LENGTH	120 AMP	150 AMP	200 AMP
13. TOTAL CIRCUIT LENGTH	120 AMP	150 AMP	200 AMP
14. TOTAL CIRCUIT LENGTH	120 AMP	150 AMP	200 AMP
15. TOTAL CIRCUIT LENGTH	120 AMP	150 AMP	200 AMP
16. TOTAL CIRCUIT LENGTH	120 AMP	150 AMP	200 AMP
17. TOTAL CIRCUIT LENGTH	120 AMP	150 AMP	200 AMP

NEW STREETLIGHT SERVICE PEDESTAL CIRCUIT 'B'

STREETLIGHT CIRCUIT 'B' CAPACITY VERIFICATION

STREETLIGHT CIRCUIT 'B' CAPACITY VERIFICATION	120 AMP	150 AMP	200 AMP
1. TOTAL CIRCUIT LENGTH	120 AMP	150 AMP	200 AMP
2. TOTAL CIRCUIT LENGTH	120 AMP	150 AMP	200 AMP
3. TOTAL CIRCUIT LENGTH	120 AMP	150 AMP	200 AMP
4. TOTAL CIRCUIT LENGTH	120 AMP	150 AMP	200 AMP
5. TOTAL CIRCUIT LENGTH	120 AMP	150 AMP	200 AMP
6. TOTAL CIRCUIT LENGTH	120 AMP	150 AMP	200 AMP
7. TOTAL CIRCUIT LENGTH	120 AMP	150 AMP	200 AMP
8. TOTAL CIRCUIT LENGTH	120 AMP	150 AMP	200 AMP
9. TOTAL CIRCUIT LENGTH	120 AMP	150 AMP	200 AMP
10. TOTAL CIRCUIT LENGTH	120 AMP	150 AMP	200 AMP
11. TOTAL CIRCUIT LENGTH	120 AMP	150 AMP	200 AMP
12. TOTAL CIRCUIT LENGTH	120 AMP	150 AMP	200 AMP
13. TOTAL CIRCUIT LENGTH	120 AMP	150 AMP	200 AMP
14. TOTAL CIRCUIT LENGTH	120 AMP	150 AMP	200 AMP
15. TOTAL CIRCUIT LENGTH	120 AMP	150 AMP	200 AMP
16. TOTAL CIRCUIT LENGTH	120 AMP	150 AMP	200 AMP
17. TOTAL CIRCUIT LENGTH	120 AMP	150 AMP	200 AMP

TRAFFIC CONTROL NOTES



1. TRAFFIC CONTROL NOTES
2. TRAFFIC CONTROL NOTES
3. TRAFFIC CONTROL NOTES
4. TRAFFIC CONTROL NOTES
5. TRAFFIC CONTROL NOTES
6. TRAFFIC CONTROL NOTES
7. TRAFFIC CONTROL NOTES
8. TRAFFIC CONTROL NOTES
9. TRAFFIC CONTROL NOTES
10. TRAFFIC CONTROL NOTES
11. TRAFFIC CONTROL NOTES
12. TRAFFIC CONTROL NOTES
13. TRAFFIC CONTROL NOTES
14. TRAFFIC CONTROL NOTES
15. TRAFFIC CONTROL NOTES
16. TRAFFIC CONTROL NOTES
17. TRAFFIC CONTROL NOTES

BASE OF BEARING


BASE OF BEARING

REMARKS

REMARKS

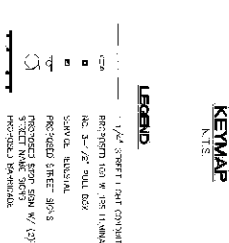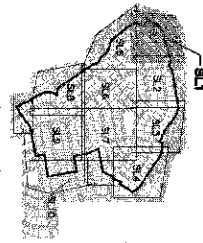

STREETLIGHT LOCATION

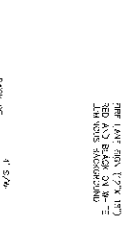

DISCLAIMER NOTE

DISCLAIMER NOTE

PRELIMINARY ISSUE FOR REVIEW

PRELIMINARY ISSUE FOR REVIEW

RHODES HOMES ARIZONA, LLC
GOLDEN VALLEY RANCH

AREA 2 PHASE A
STREET LIGHT AND TRAFFIC CONTROL PLAN 1
MOHAVE COUNTY ARIZONA

Stanley Consultants INC.

SCALE (-) 1"=40'
SCALE (+) N/A
DRAWN BY GA
CHECKED BY SH/DB
DATE 03-10-08





LEGEND

1/2 STREET 1 CAT CONDO
BROUGHT TO W. 125 11, MINAR
NO. 3-1/2 FULL BOX
SERV. RESIDUAL
PROCESSED STREET SHOWS
PROCESSED STOP SIGN W/ 125
PROCESSED SIGN W/ 125

THE LAMP FROM (12" X 18")
RED AND BLACK ON W-22
LINEN-35 BLACK-30.00

S. G. F. L. G. H. T.

10 - FOR OF P.O. 22

178

99

[illegible]

STUDIES IN

Overhead
1-828-753-5555
MIDWEST

SECRET
R44 / R. 02. 07



MOHAVE COUNTY ARIZONA



SCALE (-) 1"=40'
SCALE (+) N/A
DRAWN BY GA
CHECKED BY SH/DB
DATE 03-10-08

Time (hr)	Concentration (mg/L)
0	0
1	0
2	0
100	0

The image shows a blank ledger page with a table structure. The table has three columns labeled 'REF', 'SERIAL NO.', and 'PAGE'. To the right of the table is a circular library stamp from 'KOTA STUDY & MODEL' with 'KOTA' in the center. The stamp also contains the text 'KOTA STUDY & MODEL' and 'KOTA' around the perimeter.

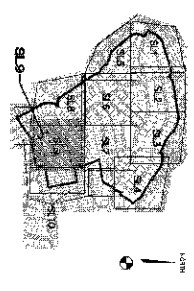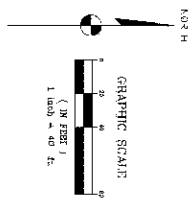

NEW STREETLIGHT SERVICE PEDESTAL CIRCUIT 'A'

STREETLIGHT CIRCUIT 'A' CAPACITY VERIFICATION

STREETLIGHT CIRCUIT 'A' CAPACITY VERIFICATION	120 AMP
1. TOTAL CIRCUIT LENGTH	120 AMP
2. TOTAL CIRCUIT LENGTH	120 AMP
3. TOTAL CIRCUIT LENGTH	120 AMP
4. TOTAL CIRCUIT LENGTH	120 AMP
5. TOTAL CIRCUIT LENGTH	120 AMP
6. TOTAL CIRCUIT LENGTH	120 AMP
7. TOTAL CIRCUIT LENGTH	120 AMP
8. TOTAL CIRCUIT LENGTH	120 AMP
9. TOTAL CIRCUIT LENGTH	120 AMP
10. TOTAL CIRCUIT LENGTH	120 AMP

NEW STREETLIGHT SERVICE PEDESTAL CIRCUIT 'B'

STREETLIGHT CIRCUIT 'B' CAPACITY VERIFICATION

STREETLIGHT CIRCUIT 'B' CAPACITY VERIFICATION	120 AMP
1. TOTAL CIRCUIT LENGTH	120 AMP
2. TOTAL CIRCUIT LENGTH	120 AMP
3. TOTAL CIRCUIT LENGTH	120 AMP
4. TOTAL CIRCUIT LENGTH	120 AMP
5. TOTAL CIRCUIT LENGTH	120 AMP
6. TOTAL CIRCUIT LENGTH	120 AMP
7. TOTAL CIRCUIT LENGTH	120 AMP
8. TOTAL CIRCUIT LENGTH	120 AMP
9. TOTAL CIRCUIT LENGTH	120 AMP
10. TOTAL CIRCUIT LENGTH	120 AMP

TRAFFIC CONSTRUCTION NOTES

1. INSTALL NEW 12" DIA. CONCRETE PAVEMENT FOR NEW TRAFFIC LANE.
2. INSTALL NEW 12" DIA. CONCRETE PAVEMENT FOR NEW TRAFFIC LANE.
3. INSTALL NEW 12" DIA. CONCRETE PAVEMENT FOR NEW TRAFFIC LANE.
4. INSTALL NEW 12" DIA. CONCRETE PAVEMENT FOR NEW TRAFFIC LANE.
5. INSTALL NEW 12" DIA. CONCRETE PAVEMENT FOR NEW TRAFFIC LANE.
6. INSTALL NEW 12" DIA. CONCRETE PAVEMENT FOR NEW TRAFFIC LANE.
7. INSTALL NEW 12" DIA. CONCRETE PAVEMENT FOR NEW TRAFFIC LANE.
8. INSTALL NEW 12" DIA. CONCRETE PAVEMENT FOR NEW TRAFFIC LANE.
9. INSTALL NEW 12" DIA. CONCRETE PAVEMENT FOR NEW TRAFFIC LANE.
10. INSTALL NEW 12" DIA. CONCRETE PAVEMENT FOR NEW TRAFFIC LANE.

LEGEND

- 1. 12" DIA. CONCRETE PAVEMENT
- 2. 12" DIA. CONCRETE PAVEMENT
- 3. 12" DIA. CONCRETE PAVEMENT
- 4. 12" DIA. CONCRETE PAVEMENT
- 5. 12" DIA. CONCRETE PAVEMENT
- 6. 12" DIA. CONCRETE PAVEMENT
- 7. 12" DIA. CONCRETE PAVEMENT
- 8. 12" DIA. CONCRETE PAVEMENT
- 9. 12" DIA. CONCRETE PAVEMENT
- 10. 12" DIA. CONCRETE PAVEMENT

DISCLAIMER NOTE

THESE PLANS AND SPECIFICATIONS ARE PREPARED BY STANLEY CONSULTANTS INC. FOR THE USE OF THE CLIENT. THE CLIENT IS RESPONSIBLE FOR THE ACCURACY AND COMPLETENESS OF THE INFORMATION PROVIDED TO STANLEY CONSULTANTS INC. STANLEY CONSULTANTS INC. DOES NOT WARRANT THE ACCURACY OR COMPLETENESS OF THE INFORMATION PROVIDED TO STANLEY CONSULTANTS INC. STANLEY CONSULTANTS INC. IS NOT RESPONSIBLE FOR ANY ERRORS OR OMISSIONS IN THESE PLANS AND SPECIFICATIONS.

PRC PRIMARY ISSUE FOR REVIEW

NOT FOR CONSTRUCTION




DATE: 03-10-08

LEGEND

- 1. 12" DIA. CONCRETE PAVEMENT
- 2. 12" DIA. CONCRETE PAVEMENT
- 3. 12" DIA. CONCRETE PAVEMENT
- 4. 12" DIA. CONCRETE PAVEMENT
- 5. 12" DIA. CONCRETE PAVEMENT
- 6. 12" DIA. CONCRETE PAVEMENT
- 7. 12" DIA. CONCRETE PAVEMENT
- 8. 12" DIA. CONCRETE PAVEMENT
- 9. 12" DIA. CONCRETE PAVEMENT
- 10. 12" DIA. CONCRETE PAVEMENT





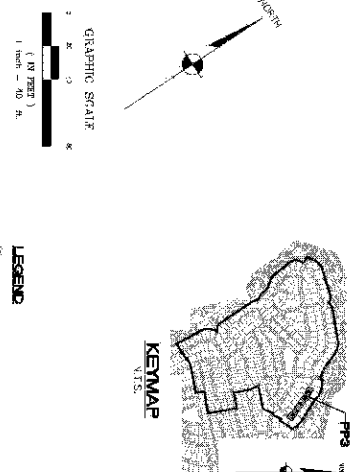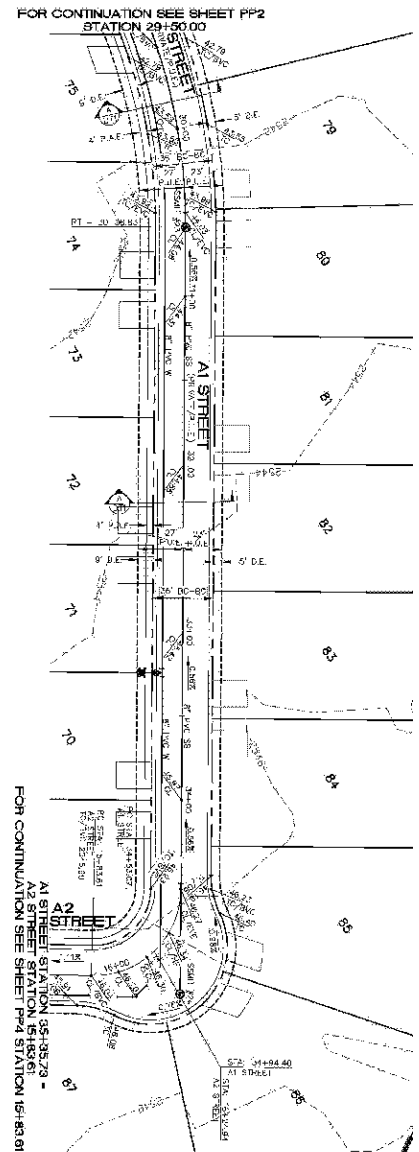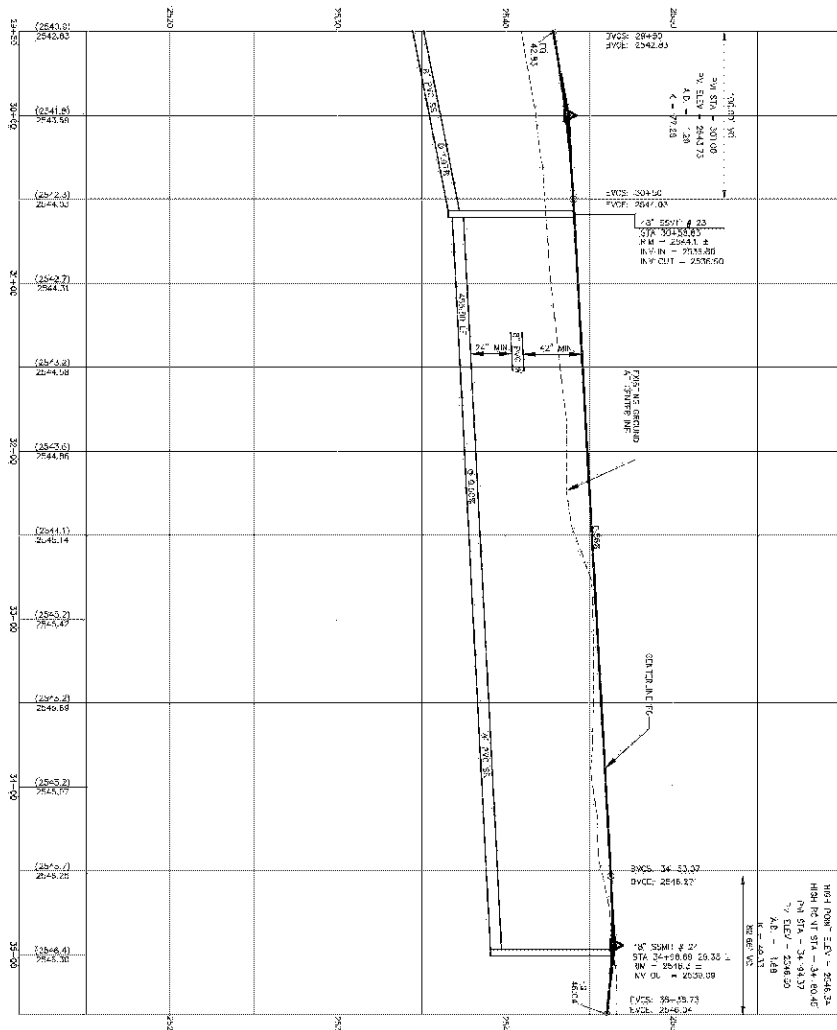

PRELIMINARY ISSUE - FOR REVIEW
NOT FOR CONSTRUCTION 03.10.06

DISCLAIMER NOTICE

UTILITY LOCATIONS SINCE
RE-LOC AND A UTILITY MA
GIVE. IT'S ALL BE THE
CONTRACTOR'S RESPONSIBILITY
TO DETERMINE THE EXACT

Call
before you
dig

1-800-4-A-DIG

1-800-782-5343
(1-800-782-5343)

AND OUTSTANDING GROWTH
THE SECTOR.

before you
Overhead

NO. 580000, 100 0110, 1-2
NO. 580000, 100 0110, 1-2
1-578-713-5571
UNIVERSITY

PRELIMINARY ISSUE - CO2 REVIEW

NOT FOR CONSTRUCTION 03-10-06

FEMA FLOOD ZONE
FEMA MAP PANEL NO. 040068 2528C
MAP FLOOD ZONE OCT 20, 2000
FLOOD AREA 2 LIES WITHIN AN AREA
DESIGNATED AS A FLOOD FLOOD ZONE "C"
IS OUTSIDE THE AREA OF THE 100-YEAR FLOOD

29

GEOTECHNICAL NOTE:

AL. CONSTRUCTION SMALL CONTRACTORS IN THE
SOUTH REPORT PREPARED BY THE AMERICAN SOILS
ENGINEERING, INC.
DATE: 12 SEP 1968 OF
PROJECT No: 1060-075

Рис. 10. Числа h и h'

DEFORMATION: ALLOY CAST 2" DIA., SPT IN CONC. 85 FT., WDR 4 1/2 INH. SINKING 1/4 CONC. 2 IN. DIA. 5 FT. DIA. 8 1/4 IN. AND 1 1/2 IN.

IN THE SECTION 2-5 (N.Y. M.P. D.2. AND 100 FT. W.), 3" (AN. 7") (S)
61.8 100-3"

GEOTECHNICAL NOTE:

AL. CONSULTING SERIAL CONTOUR MATH. IT-
SKILLS REPORT PREPARED BY: AMERICAN SOILS
ENGINEERING, LLC.
DATE: 12/20/2011

PTC Ltd. No.: 1060-070

FEMA FLOOD ZONE
FEMA 6477 PANEL NO. 04068 2325C

MAP UPDATE: OCT 20, 2000
F USE A E' AREA 2 LIES WITHIN A AREA
DESIGNATED AS A FLOOD PLAIN ZONE "C" WHICH

IS INSIDE THE SEA OF THE LAST EPOCH.

1

DISCLAIMER NOTE
UTILITY LOCATIONS SHOWN
ARE FOR INFORMATION ONLY. THEY MAY
NOT BE ACCURATE.
Call
Avoid drilling underground
utility lines. If it's not on the map, it's not there.

before you
die

1-800-782-5343
(1-800-253-4343)

And, of course, growth in the market.

before you
Overhead

NO SHOW ON 011113
NO SHOW AT 7-7-80 2PM
LOCA 104
1-978-754-5591
UNCLASS

PRELIMINARY ISSUE - C3 REVIEW

NOT FOR CONSTRUCTION 03-06

RHODES HOMES ARIZONA, LLC
GOLDEN VALLEY RANCH

AREA 2 PHASE A
SHEET PLAN AND PROFILE

MOHAVE COUNTY





ARIZONA

 3600 N. Eastern Avenue, Suite 700
Las Vegas, Nevada 89119
(702) 369-9386 Fax (702) 369-9788
www.stanleygroup.com

Stanley Consultants INC.

SCALE (-) 1"=40'
SCALE (+) 1"=4'
DRAWN BY GA
CHECKED BY SH/D
DATE 03-10-06

[illegible]

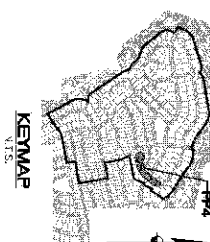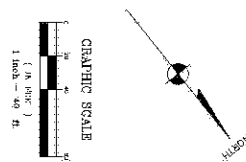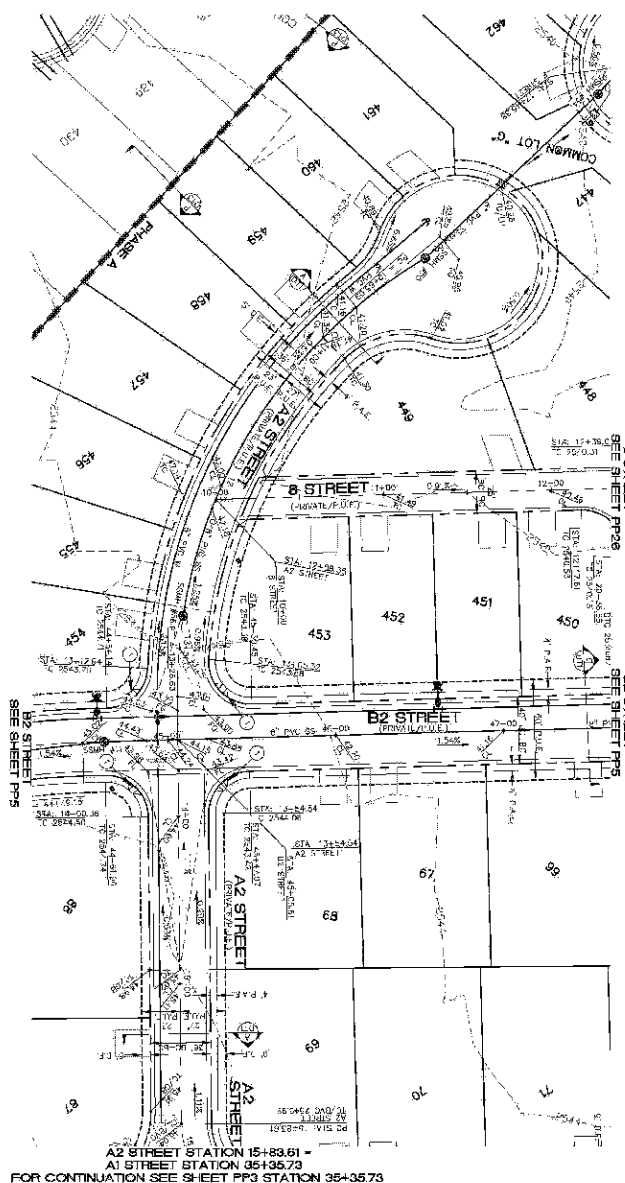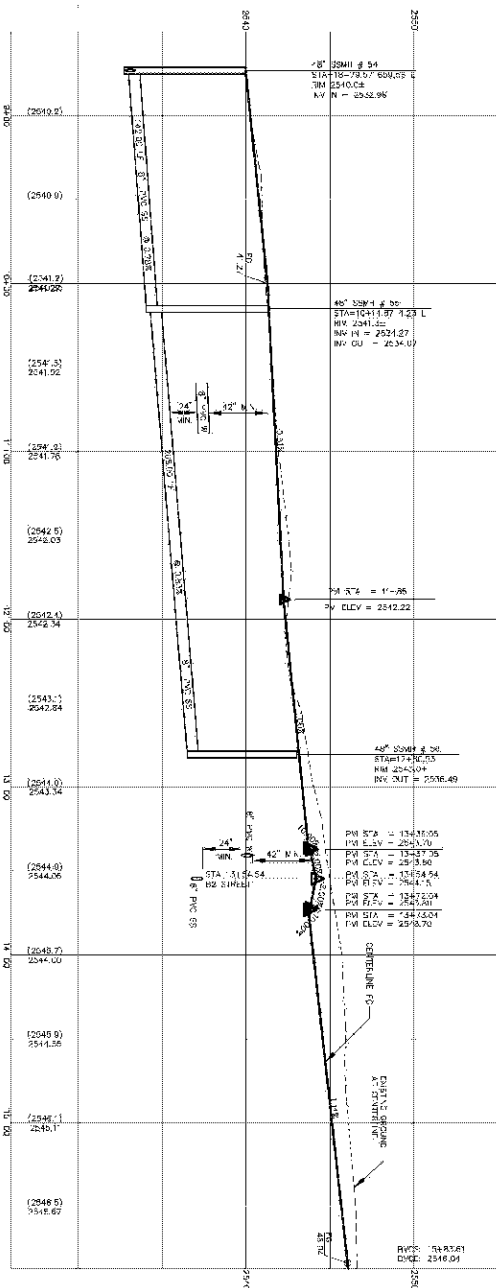



DISCLAIMER NOTE
THESE PLANS AND SPECIFICATIONS ARE PREPARED BY STANLEY CONSULTANTS INC. FOR THE USE OF THE CLIENT. THE CLIENT IS RESPONSIBLE FOR THE ACCURACY AND COMPLETENESS OF THE INFORMATION PROVIDED TO STANLEY CONSULTANTS INC. AND FOR THE RESULTS OF THE PROJECT. STANLEY CONSULTANTS INC. DOES NOT WARRANT THE ACCURACY OR COMPLETENESS OF THE INFORMATION PROVIDED TO IT, NOR DOES IT WARRANT THE RESULTS OF THE PROJECT. THE CLIENT'S USE OF THESE PLANS AND SPECIFICATIONS IS AT ITS OWN RISK. STANLEY CONSULTANTS INC. SHALL NOT BE LIABLE FOR ANY DAMAGES, INCLUDING CONSEQUENTIAL DAMAGES, ARISING OUT OF OR RESULTING FROM THE USE OF THESE PLANS AND SPECIFICATIONS.

FEMA FLOOD ZONE
FEMA FLOOD ZONE NO. 000000 000000
FLOOD ZONE NO. 000000 000000
FLOOD ZONE NO. 000000 000000

GEOTECHNICAL NOTE:
ALL CONSTRUCTION SHALL BE IN ACCORDANCE WITH THE GEOTECHNICAL REPORT DATED 03/10/08 BY STANLEY CONSULTANTS INC. THE CLIENT SHALL BE RESPONSIBLE FOR THE ACCURACY AND COMPLETENESS OF THE INFORMATION PROVIDED TO STANLEY CONSULTANTS INC. AND FOR THE RESULTS OF THE PROJECT.

BASE OF BEARINGS
ALL BEARINGS ARE GIVEN AS TRUE BEARINGS. THE TRUE BEARING OF THE LINE FROM THE INTERSECTION OF A2 STREET AND B STREET TO THE INTERSECTION OF A2 STREET AND B2 STREET IS 115° 15' 00". THE TRUE BEARING OF THE LINE FROM THE INTERSECTION OF A2 STREET AND B2 STREET TO THE INTERSECTION OF A2 STREET AND B STREET IS 115° 15' 00".

LEGEND
- EXISTING GRADE
- PROPOSED GRADE
- EXISTING ELEVATION
- PROPOSED ELEVATION
- EXISTING CURVE
- PROPOSED CURVE
- EXISTING CENTERLINE
- PROPOSED CENTERLINE
- EXISTING RIGHT-OF-WAY
- PROPOSED RIGHT-OF-WAY
- EXISTING RIGHT-OF-WAY
- PROPOSED RIGHT-OF-WAY

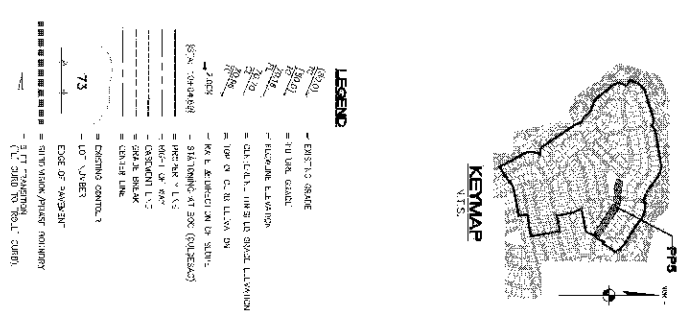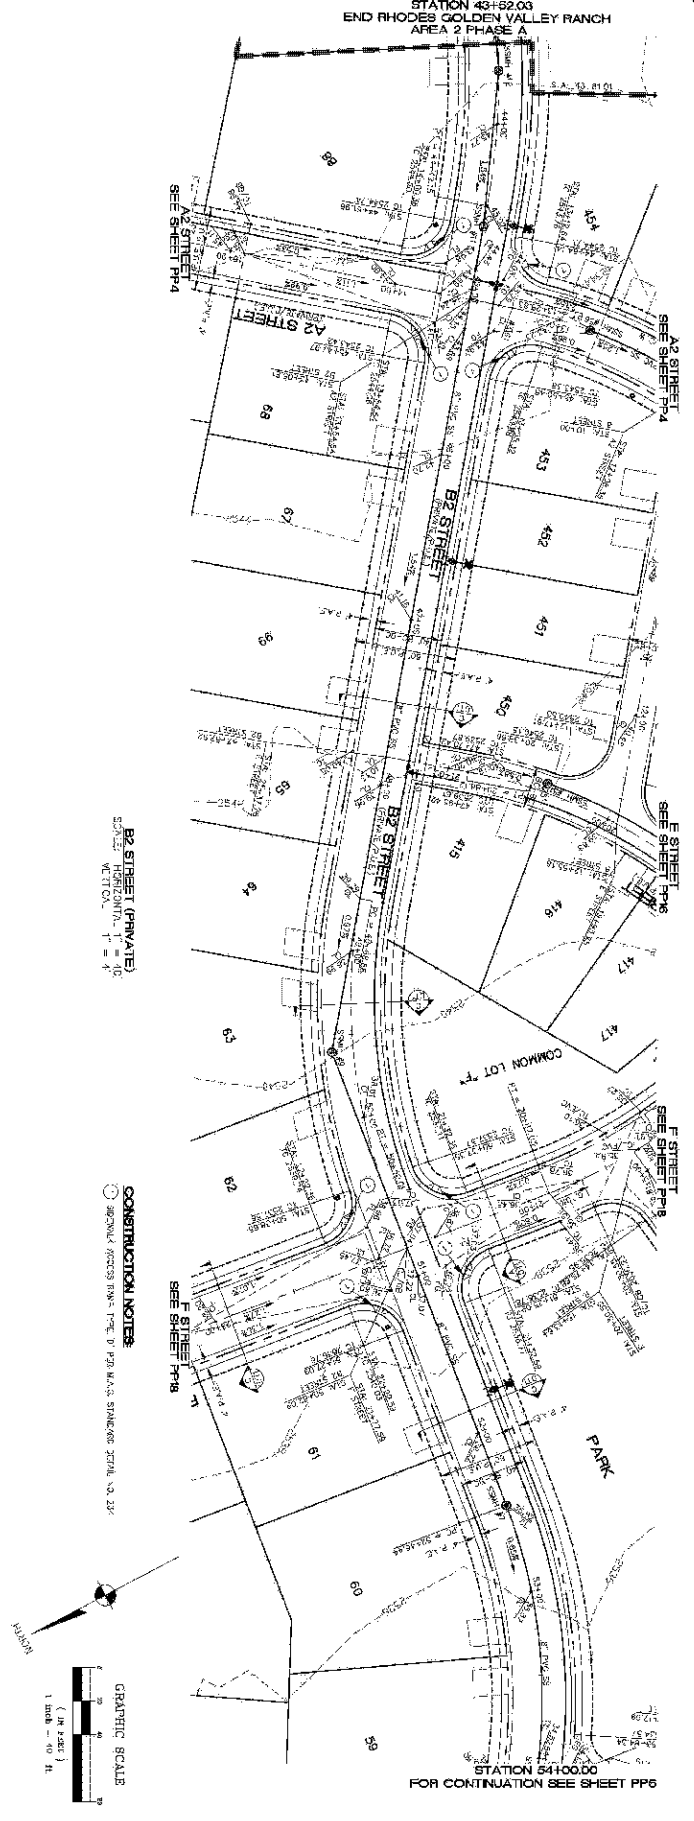[illegible]

PHASE A
PLAN AND PROFILE


[illegible]

47 07 31 384-115
 SCL 576121#
 B4/R.D. 02

S44
 PPS




RHODES H
 GOLDE
 ARE
 B2 STREET
 MOHAVE COUNTY

[illegible]

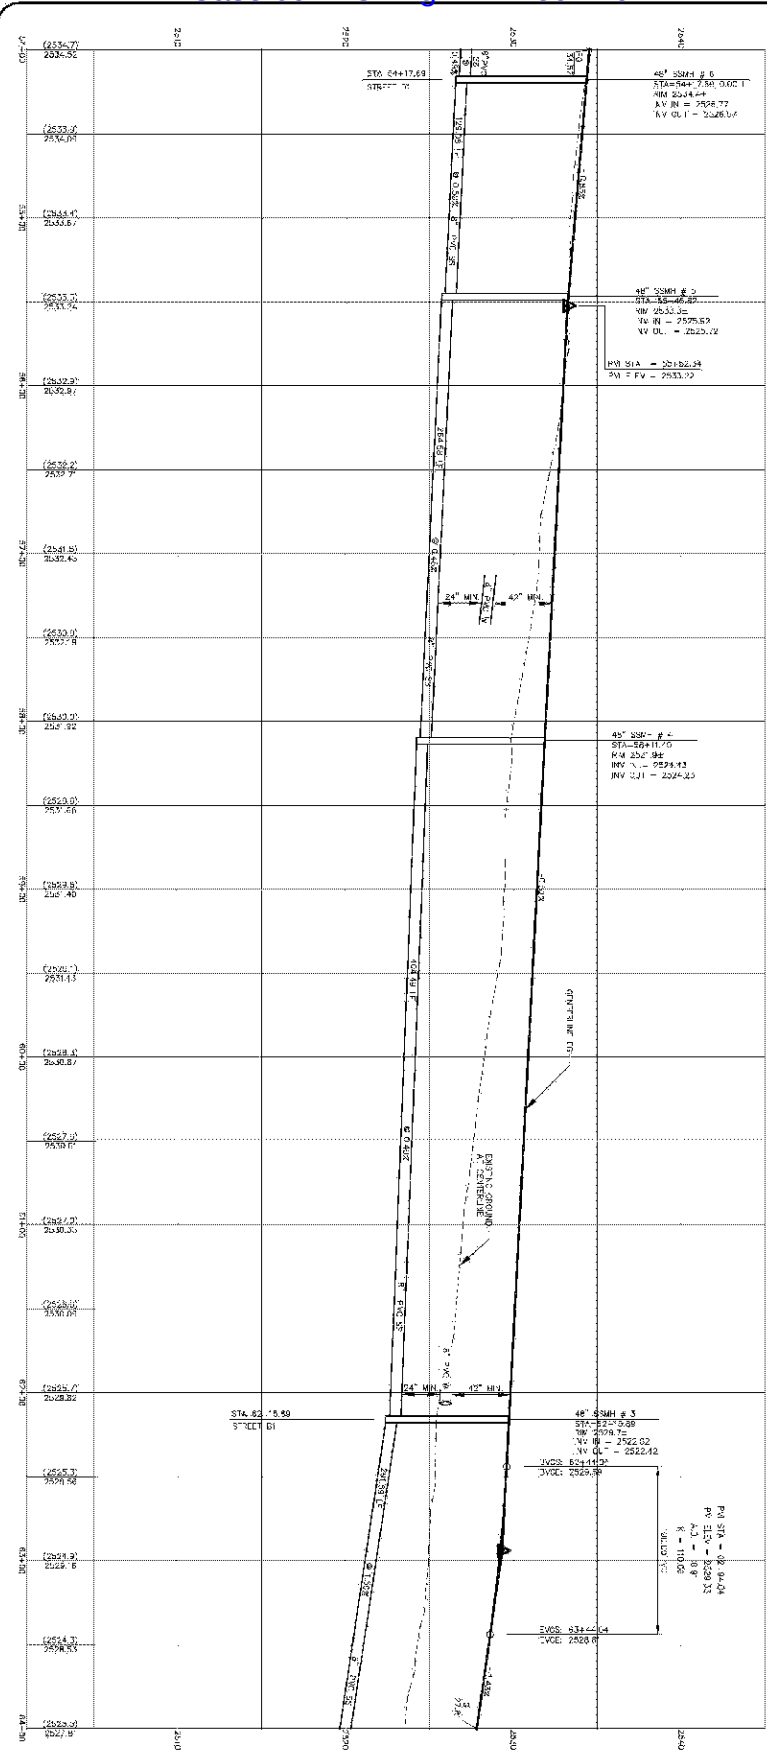

B2 STREET (PRIVATE)
SCALE: HORIZ. 1" = 40'
VERT. 1" = 10'

CONSTRUCTION NOTES
1. SEE SHEET PP6 FOR B2 STREET PROPOSED
2. SEE SHEET PP7 FOR B2 STREET PROPOSED

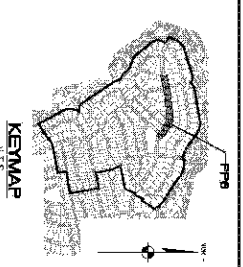
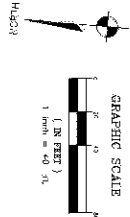
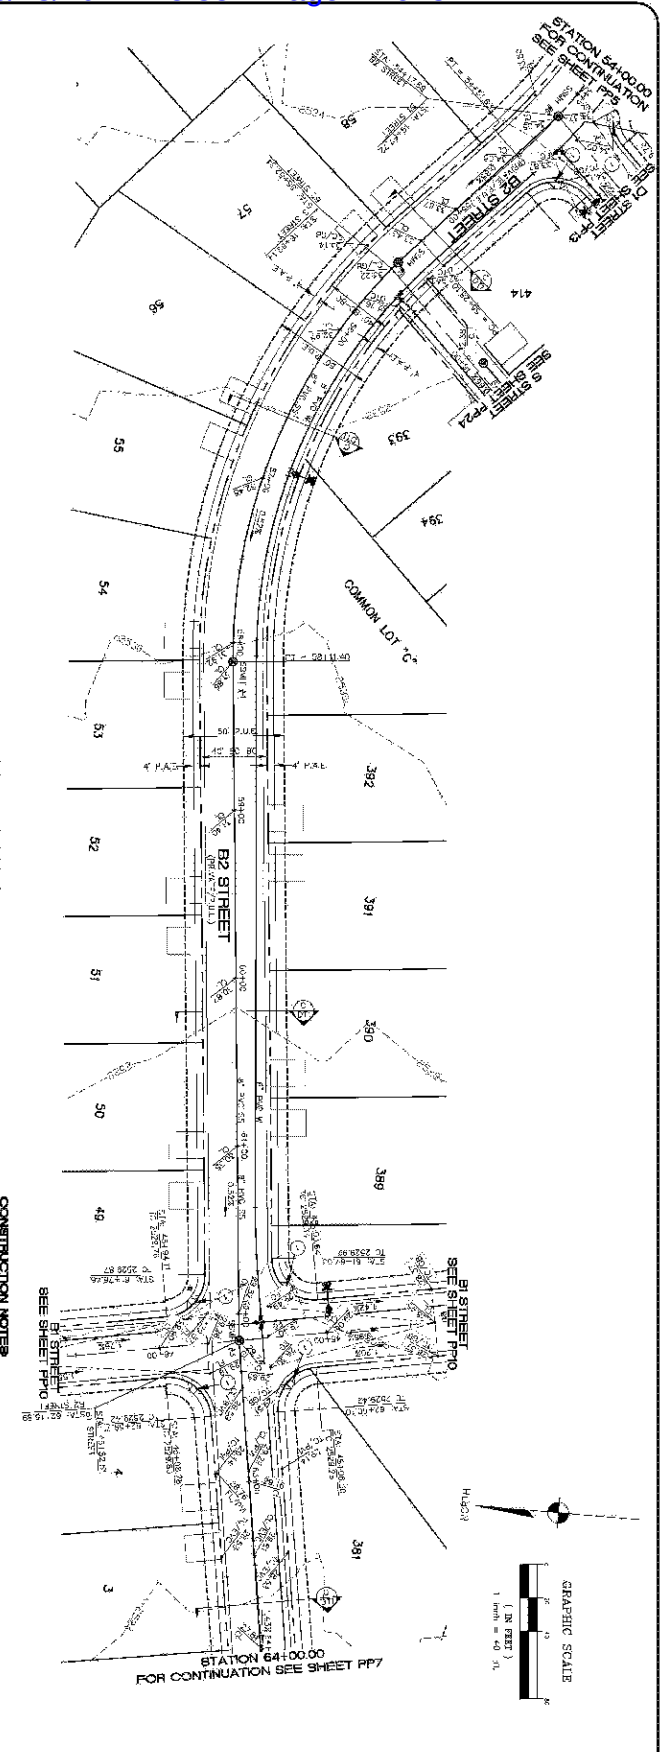


DISCLAIMER NOTE
THESE PLANS AND SPECIFICATIONS ARE PREPARED BY STANLEY CONSULTANTS INC. FOR THE USE OF THE CLIENT. THE CLIENT IS RESPONSIBLE FOR THE ACCURACY AND COMPLETENESS OF THE INFORMATION PROVIDED TO STANLEY CONSULTANTS INC. AND FOR THE RESULTS OF THE DESIGN AND CONSTRUCTION OF THE PROJECT. STANLEY CONSULTANTS INC. DOES NOT WARRANT THE ACCURACY OR COMPLETENESS OF THE INFORMATION PROVIDED TO IT, NOR DOES IT WARRANT THE RESULTS OF THE DESIGN AND CONSTRUCTION OF THE PROJECT. THE CLIENT SHALL BE RESPONSIBLE FOR OBTAINING ALL NECESSARY PERMITS AND FOR THE RESULTS OF THE DESIGN AND CONSTRUCTION OF THE PROJECT.

GEOTECHNICAL NOTE:
THE GEOTECHNICAL ENGINEER HAS REVIEWED THE PLANS AND SPECIFICATIONS AND HAS DETERMINED THAT THE PROPOSED DESIGN IS FEASIBLE AND THAT THE PROPOSED CONSTRUCTION METHODS ARE APPROPRIATE FOR THE SITE CONDITIONS. THE GEOTECHNICAL ENGINEER HAS NOT CONDUCTED ANY FIELD OR LABORATORY TESTING OF THE SOILS AT THE SITE, AND THEREFORE THE DESIGN IS BASED ON THE INFORMATION PROVIDED TO IT BY THE CLIENT.

FEMA FLOOD ZONE
THE FLOOD ZONE MAPS HAVE BEEN REVIEWED AND THE PROPOSED DESIGN IS FEASIBLE AND THAT THE PROPOSED CONSTRUCTION METHODS ARE APPROPRIATE FOR THE SITE CONDITIONS. THE FLOOD ZONE MAPS HAVE NOT BEEN CONDUCTED ANY FIELD OR LABORATORY TESTING OF THE SOILS AT THE SITE, AND THEREFORE THE DESIGN IS BASED ON THE INFORMATION PROVIDED TO IT BY THE CLIENT.

LEGEND
- B2 STREET PROPOSED
- B2 STREET EXISTING
- B2 STREET WIDENING
- B2 STREET CLOSURE
- B2 STREET RECONSTRUCTION
- B2 STREET IMPROVEMENTS
- B2 STREET MAINTENANCE
- B2 STREET REPAIRS
- B2 STREET REPLACEMENTS
- B2 STREET MODIFICATIONS
- B2 STREET ADJUSTMENTS
- B2 STREET CORRECTIONS
- B2 STREET ENHANCEMENTS
- B2 STREET UPGRADES
- B2 STREET DOWNGRADES
- B2 STREET DEGRADATIONS
- B2 STREET DESTRUCTION
- B2 STREET DEMOLITION
- B2 STREET REMOVAL
- B2 STREET ABANDONMENT
- B2 STREET CLOSURE
- B2 STREET RECONSTRUCTION
- B2 STREET IMPROVEMENTS
- B2 STREET MAINTENANCE
- B2 STREET REPAIRS
- B2 STREET REPLACEMENTS
- B2 STREET MODIFICATIONS
- B2 STREET ADJUSTMENTS
- B2 STREET CORRECTIONS
- B2 STREET ENHANCEMENTS
- B2 STREET UPGRADES
- B2 STREET DOWNGRADES
- B2 STREET DEGRADATIONS
- B2 STREET DESTRUCTION
- B2 STREET DEMOLITION
- B2 STREET REMOVAL
- B2 STREET ABANDONMENT

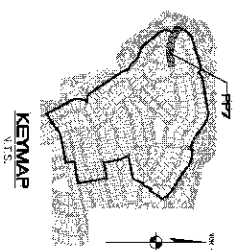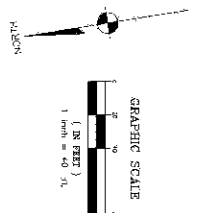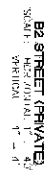

CONSTRUCTION NOTES:
 1. SEE "K ADDRESS" PANEL TOP "Y" FOR HARD STANCHION DETAILS. PG. 234

LEGO

1. LEGO

2. LEGO

3. LEGO

262. LEGO

BASIS OF BEARING

NON-HOT-SPOT EARTH-1-2 WEST LIME OF THE VERTICALLY QUANTIFIED (A-1/4); SE SECTION OF, EARTH-5 ON NORTH, RAYON DE MER, G. A. A. SA-1, IN WESTERN MICHIGAN, SOUTH OF, NORTH, AS DETERMINED BY THE ARIZONA COORDINATE SYSTEM OF 1983 (NAD-83), WEST 7000.

LONG. "82 32" - LAT. 10N

5. $\text{CNR} \frac{1}{4} \text{ OR } \leq \frac{1}{2} =$

РФНЧМА-ЭК № "5" "4" "1.05.07"

DEGRADATION AT 100°C FOR 24 HRS. IN CONCENTRATIONS OF 10%, 20%, 30%, 40%, 50%, 60%, 70%, 80%, 90%, AND 100% IN THE SOLUTIONS. THE RESULTS OF THE DEGRADATION STUDIES ARE GIVEN IN TABLE I.

GEOTECHNICAL NOTE:

SOILS REPORT PREPARED BY: AMERICAN SOILS
ENGINEERING, LLC
DATE: 2 JUL 2008 OF
PROJECT No.: 1060-073

FEMA FLOOD ZONE

F-AREA A-C AREA LIES WITHIN AN AREA
DESIGNATED AS A FLOOD PLANE ZONE C WHICH
IS OUTSIDE THE AREA OF THE 100-YEAR FLOOD

DISCLAIMER NOTE

Call before you dig

HEADLINE: 25116000 Q.
COUNTRIES: COUNTRIES: TN.

THAT ALL EXISTING UTILITIES
ARE SHOWN HEREON. T-1-

100 250000 0.1-2
 100 250000 0.1-2

-REPLACEMENT CODE - C/ RELEVANT FOR CONTACT INFORMATION 202

AREA 2 PHASE A
STREET PLAN AND PROFILE



MOHAVE COUNTY



Stanley Consultants INC.

6875 N. Laramie Avenue, Suite 700
Las Vegas, Nevada 89119
(702) 389-9796 Fax (702) 389-9793
www.sconeysgroup.com

SCALE (-) 1"=40'
SCALE (+) 1"=4'
DRAWN BY GA
CHECKED BY SH/D
DATE 03-10-06



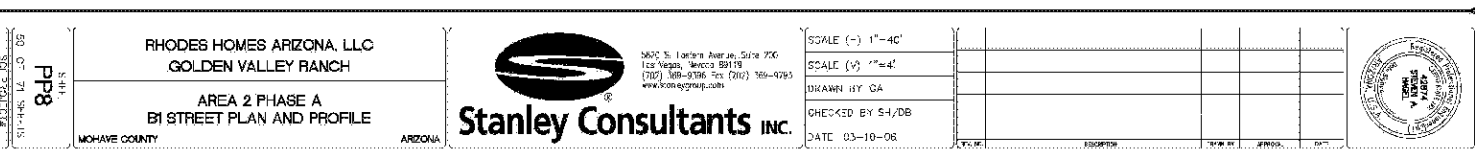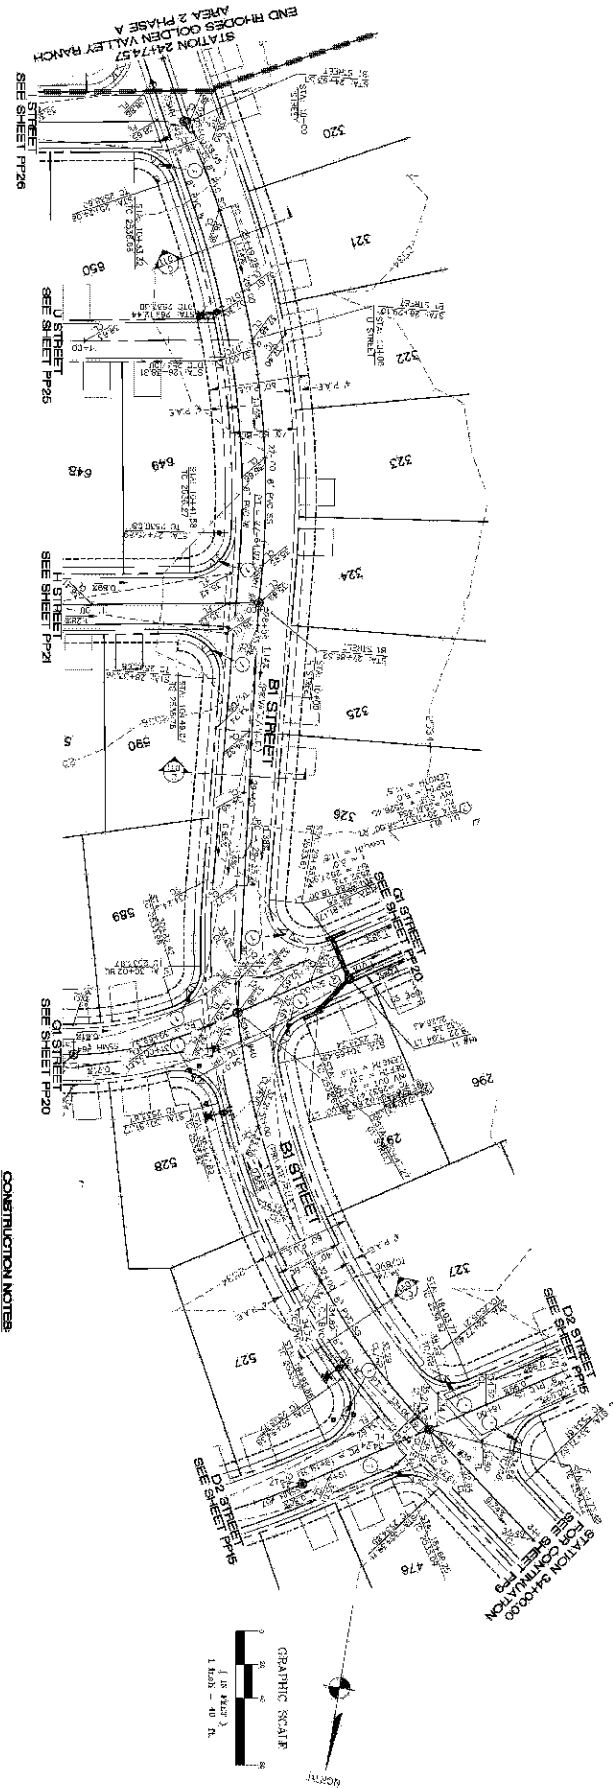

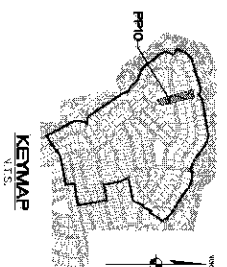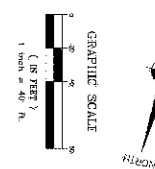

① SIDEWALK: ACROSS FROM "TIE O' PER W.A.O. STANDARD DEPT. NO. 23"

5/18 RA:aff



3630 S. Eastern Avenue, Suite 750
Las Vegas, Nevada 89119
(702) 369-9786 Fax (702) 369-9787
www.stanleygroup.com

Stanley Consultants INC.

SEALING REPORT PREPARED BY: AMERICAN SOILS
ENGINEERING, LLC
DATE: 2/28/2008 OF
PROJECT No.: 1060-073

FLOOD AREA 2 LIES WITHIN AN AREA DESIGNATED AS A FLOOD ZONE "C," WHICH IS OUTSIDE THE AREA OF THE 100-YEAR STORM.

Call
before you
dig
1-800-4-A-PILE

1-800-782-5348
(1-800-296-1140)

[illegible]



before you
Overhead


NO SHOW ON 01/11/12
NO SHOW on 11-1-12
L00A129

1-978-754-5591
URGENT

PRELIMINARY ISSUE - C? REVIEW
NOT FOR CONSTRUCTION 03 / 0 08



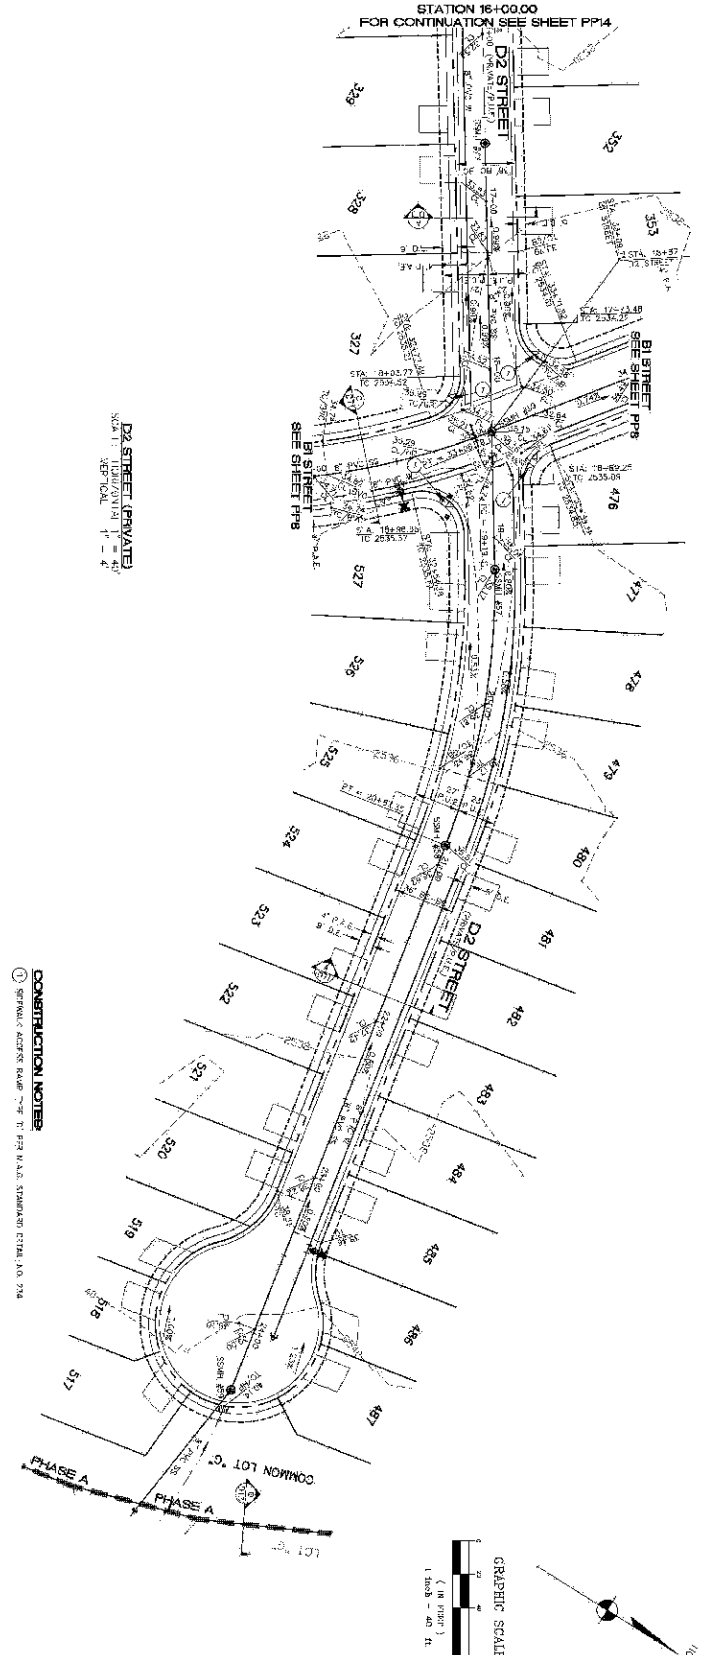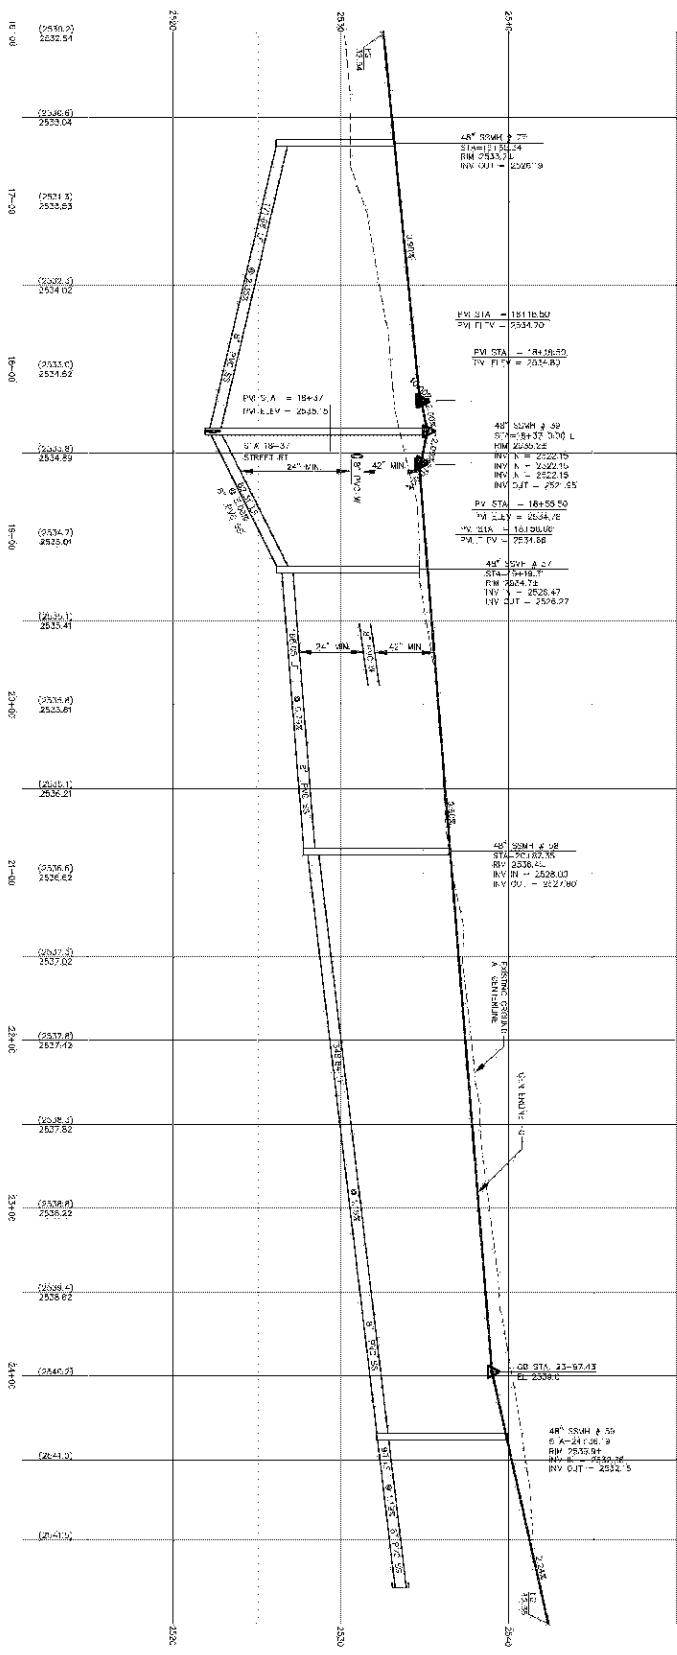

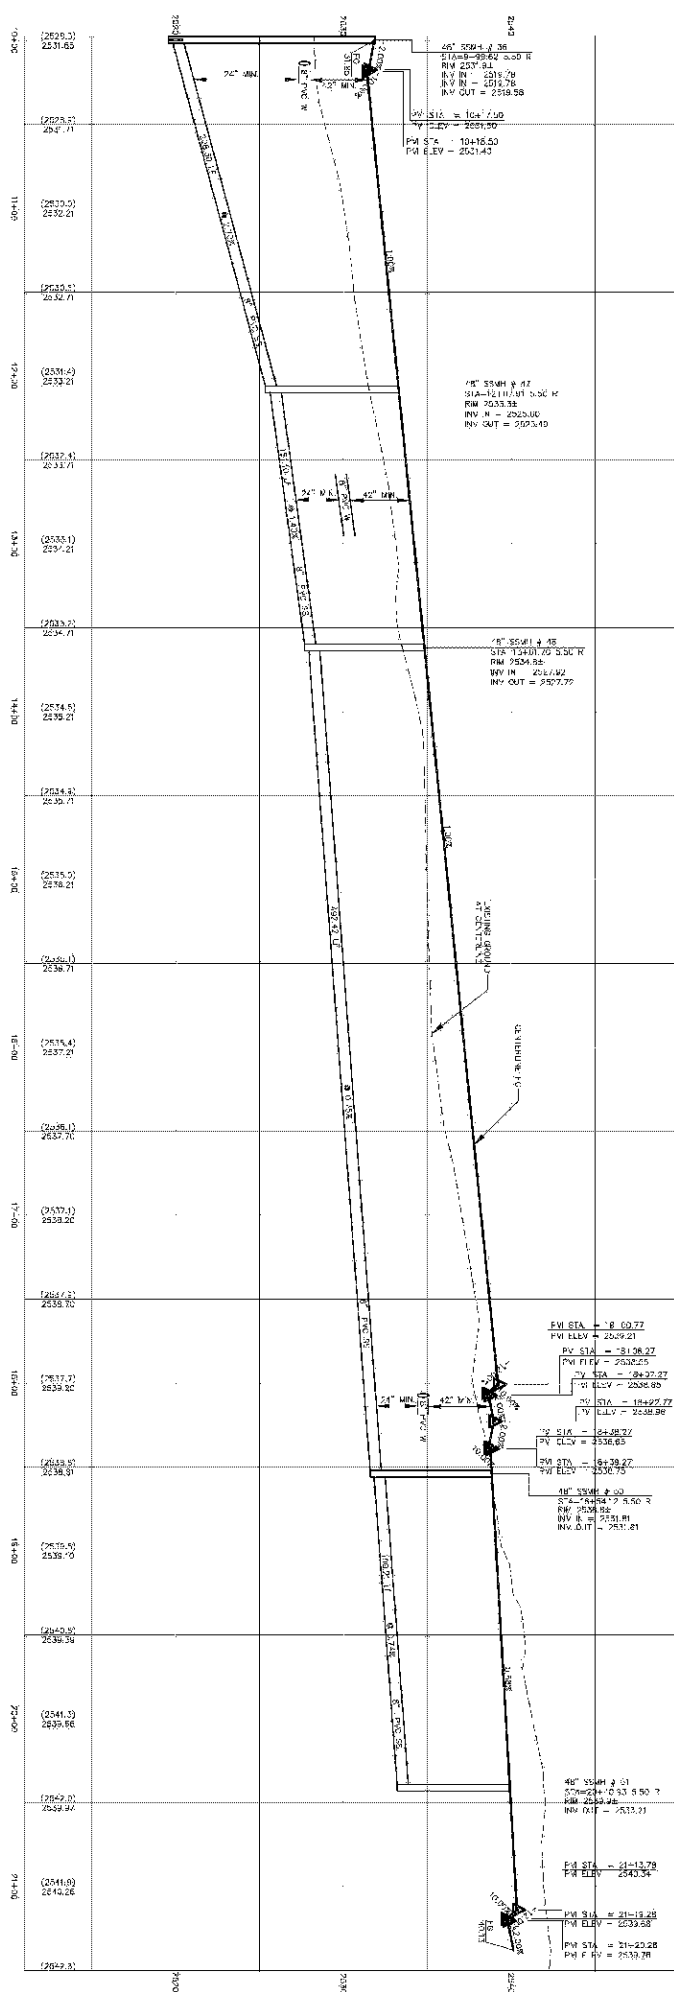

BENCHMARK

DATE: 04/25/2011 14:25:11

SYNOPSIS: 1/4 CORP / 1 -

1. NAME: 1/4 CORP / 1 -

2. ADDRESS: 1/4 CORP / 1 -

3. CITY: 1/4 CORP / 1 -

4. STATE: 1/4 CORP / 1 -

5. ZIP: 1/4 CORP / 1 -

6. PHONE: 1/4 CORP / 1 -

7. FAX: 1/4 CORP / 1 -

8. E-MAIL: 1/4 CORP / 1 -

9. WEBSITE: 1/4 CORP / 1 -

10. COMMENTS: 1/4 CORP / 1 -

11. NOTES: 1/4 CORP / 1 -

12. REFERENCES: 1/4 CORP / 1 -

13. OTHER: 1/4 CORP / 1 -

14. TOTAL: 1/4 CORP / 1 -

15. STATUS: 1/4 CORP / 1 -

16. ACTION: 1/4 CORP / 1 -

17. DATE: 1/4 CORP / 1 -

18. TIME: 1/4 CORP / 1 -

19. USER: 1/4 CORP / 1 -

20. PASSWORD: 1/4 CORP / 1 -

21. COMMENTS: 1/4 CORP / 1 -

22. NOTES: 1/4 CORP / 1 -

23. REFERENCES: 1/4 CORP / 1 -

24. OTHER: 1/4 CORP / 1 -

25. TOTAL: 1/4 CORP / 1 -

26. STATUS: 1/4 CORP / 1 -

27. ACTION: 1/4 CORP / 1 -

28. DATE: 1/4 CORP / 1 -

29. TIME: 1/4 CORP / 1 -

30. USER: 1/4 CORP / 1 -

31. PASSWORD: 1/4 CORP / 1 -

32. COMMENTS: 1/4 CORP / 1 -

33. NOTES: 1/4 CORP / 1 -

34. REFERENCES: 1/4 CORP / 1 -

35. OTHER: 1/4 CORP / 1 -

36. TOTAL: 1/4 CORP / 1 -

37. STATUS: 1/4 CORP / 1 -

38. ACTION: 1/4 CORP / 1 -

39. DATE: 1/4 CORP / 1 -

40. TIME: 1/4 CORP / 1 -

41. USER: 1/4 CORP / 1 -

42. PASSWORD: 1/4 CORP / 1 -

43. COMMENTS: 1/4 CORP / 1 -

44. NOTES: 1/4 CORP / 1 -

45. REFERENCES: 1/4 CORP / 1 -

46. OTHER: 1/4 CORP / 1 -

47. TOTAL: 1/4 CORP / 1 -

48. STATUS: 1/4 CORP / 1 -

49. ACTION: 1/4 CORP / 1 -

50. DATE: 1/4 CORP / 1 -

51. TIME: 1/4 CORP / 1 -

52. USER: 1/4 CORP / 1 -

53. PASSWORD: 1/4 CORP / 1 -

54. COMMENTS: 1/4 CORP / 1 -

55. NOTES: 1/4 CORP / 1 -

56. REFERENCES: 1/4 CORP / 1 -

57. OTHER: 1/4 CORP / 1 -

58. TOTAL: 1/4 CORP / 1 -

59. STATUS: 1/4 CORP / 1 -

60. ACTION: 1/4 CORP / 1 -

61. DATE: 1/4 CORP / 1 -

62. TIME: 1/4 CORP / 1 -

63. USER: 1/4 CORP / 1 -

64. PASSWORD: 1/4 CORP / 1 -

65. COMMENTS: 1/4 CORP / 1 -

66. NOTES: 1/4 CORP / 1 -

67. REFERENCES: 1/4 CORP / 1 -

68. OTHER: 1/4 CORP / 1 -

69. TOTAL: 1/4 CORP / 1 -

70. STATUS: 1/4 CORP / 1 -

71. ACTION: 1/4 CORP / 1 -

72. DATE: 1/4 CORP / 1 -

73. TIME: 1/4 CORP / 1 -

74. USER: 1/4 CORP / 1 -

75. PASSWORD: 1/4 CORP / 1 -

76. COMMENTS: 1/4 CORP / 1 -

77. NOTES: 1/4 CORP / 1 -

78. REFERENCES: 1/4 CORP / 1 -

79. OTHER: 1/4 CORP / 1 -

80. TOTAL: 1/4 CORP / 1 -

81. STATUS: 1/4 CORP / 1 -

82. ACTION: 1/4 CORP / 1 -

83. DATE: 1/4 CORP / 1 -

84. TIME: 1/4 CORP / 1 -

85. USER: 1/4 CORP / 1 -

86. PASSWORD: 1/4 CORP / 1 -

87. COMMENTS: 1/4 CORP / 1 -

88. NOTES: 1/4 CORP / 1 -

89. REFERENCES: 1/4 CORP / 1 -

90. OTHER: 1/4 CORP / 1 -

91. TOTAL: 1/4 CORP / 1 -

92. STATUS: 1/4 CORP / 1 -

93. ACTION: 1/4 CORP / 1 -

94. DATE: 1/4 CORP / 1 -

95. TIME: 1/4 CORP / 1 -

96. USER: 1/4 CORP / 1 -

97. PASSWORD: 1/4 CORP / 1 -

98. COMMENTS: 1/4 CORP / 1 -

99. NOTES: 1/4 CORP / 1 -

100. REFERENCES: 1/4 CORP / 1 -

101. OTHER: 1/4 CORP / 1 -

102. TOTAL: 1/4 CORP / 1 -

103. STATUS: 1/4 CORP / 1 -

104. ACTION: 1/4 CORP / 1 -

105. DATE: 1/4 CORP / 1 -

106. TIME: 1/4 CORP / 1 -

107. USER: 1/4 CORP / 1 -

108. PASSWORD: 1/4 CORP / 1 -

109. COMMENTS: 1/4 CORP / 1 -

110. NOTES: 1/4 CORP / 1 -

111. REFERENCES: 1/4 CORP / 1 -

112. OTHER: 1/4 CORP / 1 -

113. TOTAL: 1/4 CORP / 1 -

114. STATUS: 1/4 CORP / 1 -

115. ACTION: 1/4 CORP / 1 -

116. DATE: 1/4 CORP / 1 -

117. TIME: 1/4 CORP / 1 -

118. USER: 1/4 CORP / 1 -

119. PASSWORD: 1/4 CORP / 1 -

120. COMMENTS: 1/4 CORP / 1 -

121. NOTES: 1/4 CORP / 1 -

122. REFERENCES: 1/4 CORP / 1 -

123. OTHER: 1/4 CORP / 1 -

124. TOTAL: 1/4 CORP / 1 -

125. STATUS: 1/4 CORP / 1 -

126. ACTION: 1/4 CORP / 1 -

127. DATE: 1/4 CORP / 1 -

128. TIME: 1/4 CORP / 1 -

129. USER: 1/4 CORP / 1 -

130. PASSWORD: 1/4 CORP / 1 -

131. COMMENTS: 1/4 CORP / 1 -

132. NOTES: 1/4 CORP / 1 -

133. REFERENCES: 1/4 CORP / 1 -

134. OTHER: 1/4 CORP / 1 -

135. TOTAL: 1/4 CORP / 1 -

136. STATUS: 1/4 CORP / 1 -

137. ACTION: 1/4 CORP / 1 -

138. DATE: 1/4 CORP / 1 -

139. TIME: 1/4 CORP / 1 -

140. USER: 1/4 CORP / 1 -

141. PASSWORD: 1/4 CORP / 1 -

142. COMMENTS: 1/4 CORP / 1 -

143. NOTES: 1/4 CORP / 1 -

144. REFERENCES: 1/4 CORP / 1 -

145. OTHER: 1/4 CORP / 1 -

146. TOTAL: 1/4 CORP / 1 -

147. STATUS: 1/4 CORP / 1 -

148. ACTION: 1/4 CORP / 1 -

149. DATE: 1/4 CORP / 1 -

150. TIME: 1/4 CORP / 1 -

151. USER: 1/4 CORP / 1 -

152. PASSWORD: 1/4 CORP / 1 -

153. COMMENTS: 1/4 CORP / 1 -

154. NOTES: 1/4 CORP / 1 -

155. REFERENCES: 1/4 CORP / 1 -

156. OTHER: 1/4 CORP / 1 -

157. TOTAL: 1/4 CORP / 1 -

158. STATUS: 1/4 CORP / 1 -

159. ACTION: 1/4 CORP / 1 -

160. DATE: 1/4 CORP / 1 -

161. TIME: 1/4 CORP / 1 -

162. USER: 1/4 CORP / 1 -

163. PASSWORD: 1/4 CORP / 1 -

164. COMMENTS: 1/4 CORP / 1 -

165. NOTES: 1/4 CORP / 1 -

166. REFERENCES: 1/4 CORP / 1 -

167. OTHER: 1/4 CORP / 1 -

168. TOTAL: 1/4 CORP / 1 -

169. STATUS: 1/4 CORP / 1 -

170. ACTION: 1/4 CORP / 1 -

171. DATE: 1/4 CORP / 1 -

172. TIME: 1/4 CORP / 1 -

173. USER: 1/4 CORP / 1 -

174. PASSWORD: 1/4 CORP / 1 -

175. COMMENTS: 1/4 CORP / 1 -

176. NOTES: 1/4 CORP / 1 -

177. REFERENCES: 1/4 CORP / 1 -

178. OTHER: 1/4 CORP / 1 -

179. TOTAL: 1/4 CORP / 1 -

180. STATUS: 1/4 CORP / 1 -

181. ACTION: 1/4 CORP / 1 -

182. DATE: 1/4 CORP / 1 -

183. TIME: 1/4 CORP / 1 -

184. USER: 1/4 CORP / 1 -

185. PASSWORD: 1/4 CORP / 1 -

186. COMMENTS: 1/4 CORP / 1 -

187. NOTES: 1/4 CORP / 1 -

188. REFERENCES: 1/4 CORP / 1 -

189. OTHER: 1/4 CORP / 1 -

190. TOTAL: 1/4 CORP / 1 -

191. STATUS: 1/4 CORP / 1 -

192. ACTION: 1/4 CORP / 1 -

193. DATE: 1/4 CORP / 1 -

194. TIME: 1/4 CORP / 1 -

195. USER: 1/4 CORP / 1 -

196. PASSWORD: 1/4 CORP / 1 -

197. COMMENTS: 1/4 CORP / 1 -

198. NOTES

GEOTECHNICAL NOTE:
 ALL CONSTRUCTION SHALL COMPLY WITH THE
 SOCIETY'S SPECIAL PREPARED BY AMERICAN SOCIETY
 ENGINEERING, INC.
 PARTS 1-2 SPECIFICATIONS FOR
 PROJECT NO. 1650 (25)

E STREET (PRIVATE)
 SCD 1: HORIZONTAL 1" = 40'
 VERTICAL 1" = 4'

LEGEND

[illegible]

LEGEND

CONSTRUCTION NOTES

[illegible]

GRAPHIC SCALE

10 20

(IN FEET)

1 inch = 10 ft.

6
KEYMAP
NTS

PRELIMINARY ISSUE - DO NOT REVIEW
NOT FOR CONSTRUCTION 03-10-08

RHODES HOMES ARIZONA, LLC
GOLDEN VALLEY RANCH

AREA 2 PHASE A
SHEET PLAN AND PROFILE

MOHAVE COUNTY

Stanley Consultants INC.

SCALE (-) 1"=40'


SCALE (V) 1"=4'

DRAWN BY GA

CHECKED BY S-H/DB



DATE 03-10-06



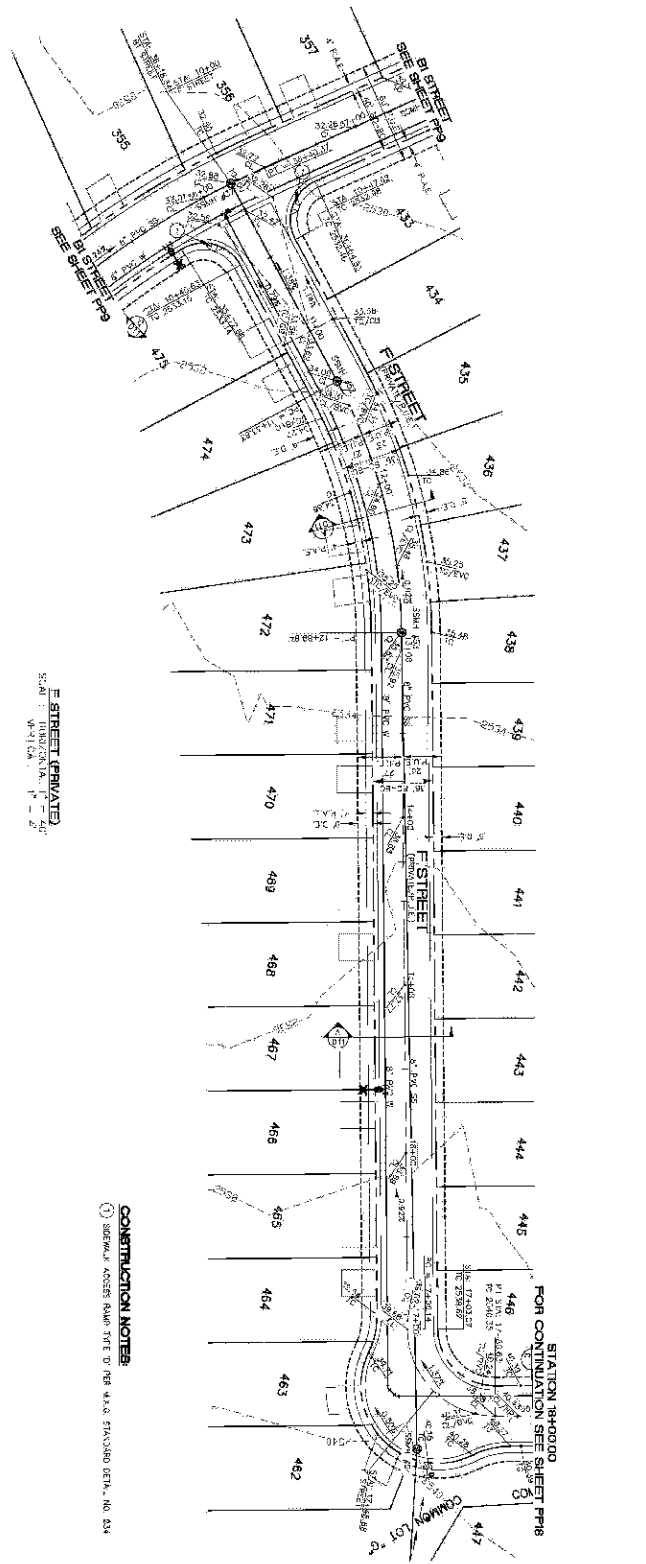

F STREET (PRIVATE)
STATION 432 TO 447
W-1 (CA) 1" = 40'

CONSTRUCTION NOTES
1) SEE PLAN FOR RAMP TYPE TO RER. W-1A STATIONED 432.4, NO. 234

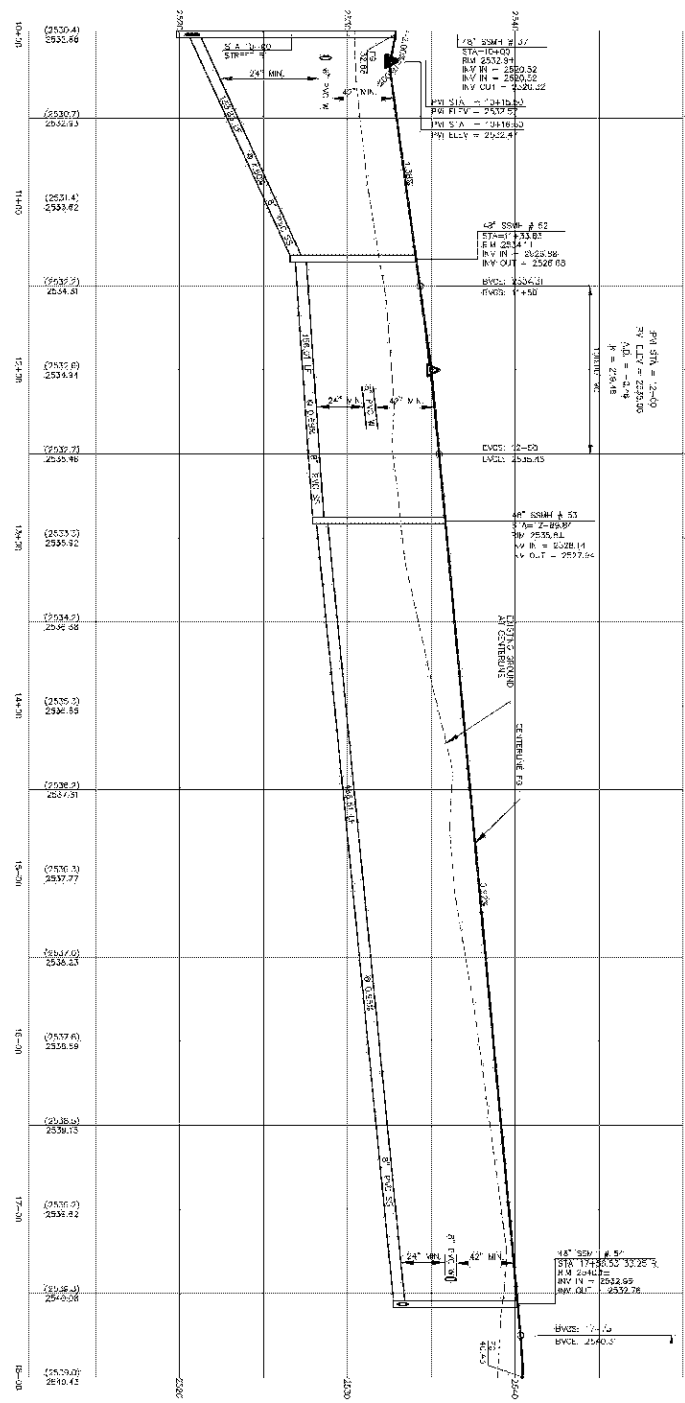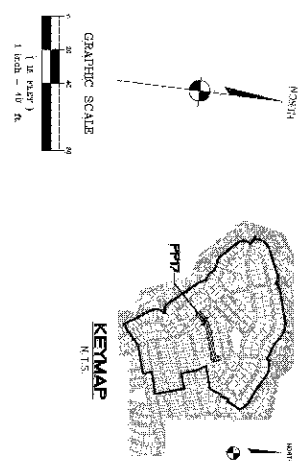

VERTICAL CURVE DATA
PVI STA = 434.00
PVI ELEV = 2532.84
BVC STA = 432.00
BVC ELEV = 2528.00
EVC STA = 436.00
EVC ELEV = 2537.68
L = 40.00
A = -2.40
G = 2.94

VERTICAL CURVE DATA
PVI STA = 434.00
PVI ELEV = 2532.84
BVC STA = 432.00
BVC ELEV = 2528.00
EVC STA = 436.00
EVC ELEV = 2537.68
L = 40.00
A = -2.40
G = 2.94

VERTICAL CURVE DATA
PVI STA = 434.00
PVI ELEV = 2532.84
BVC STA = 432.00
BVC ELEV = 2528.00
EVC STA = 436.00
EVC ELEV = 2537.68
L = 40.00
A = -2.40
G = 2.94

VERTICAL CURVE DATA
PVI STA = 434.00
PVI ELEV = 2532.84
BVC STA = 432.00
BVC ELEV = 2528.00
EVC STA = 436.00
EVC ELEV = 2537.68
L = 40.00
A = -2.40
G = 2.94

BASE OF BEARING

NOTE: ALL BEARING AND DISTANCE MEASUREMENTS ARE TO BE MADE FROM THE CORNER OF THE SECTION TO THE CORNER OF THE SECTION. ALL BEARING AND DISTANCE MEASUREMENTS ARE TO BE MADE FROM THE CORNER OF THE SECTION TO THE CORNER OF THE SECTION. ALL BEARING AND DISTANCE MEASUREMENTS ARE TO BE MADE FROM THE CORNER OF THE SECTION TO THE CORNER OF THE SECTION.

BENCHMARK

NOTE: ALL BENCHMARKS ARE TO BE MEASURED FROM THE CORNER OF THE SECTION TO THE CORNER OF THE SECTION. ALL BENCHMARKS ARE TO BE MEASURED FROM THE CORNER OF THE SECTION TO THE CORNER OF THE SECTION. ALL BENCHMARKS ARE TO BE MEASURED FROM THE CORNER OF THE SECTION TO THE CORNER OF THE SECTION.

GEOTECHNICAL NOTE

ALL CONSTRUCTION SHALL BE DONE IN ACCORDANCE WITH THE GEOTECHNICAL REPORT DATED 01/11/08 BY THE GEOTECHNICAL ENGINEER, INC. (GEO) AND THE GEOTECHNICAL ENGINEER, INC. (GEO).

FEMA FLOOD ZONE

NOTE: ALL FLOOD ZONE DATA IS TO BE MEASURED FROM THE CORNER OF THE SECTION TO THE CORNER OF THE SECTION. ALL FLOOD ZONE DATA IS TO BE MEASURED FROM THE CORNER OF THE SECTION TO THE CORNER OF THE SECTION. ALL FLOOD ZONE DATA IS TO BE MEASURED FROM THE CORNER OF THE SECTION TO THE CORNER OF THE SECTION.




DISCLAIMER NOTE

THIS PLAN AND PROFILE ARE PRELIMINARY AND NOT FOR CONSTRUCTION. THE USER OF THIS PLAN AND PROFILE SHALL BE RESPONSIBLE FOR OBTAINING ALL NECESSARY PERMITS AND FOR THE ACCURACY OF THE DATA. THE USER OF THIS PLAN AND PROFILE SHALL BE RESPONSIBLE FOR OBTAINING ALL NECESSARY PERMITS AND FOR THE ACCURACY OF THE DATA. THE USER OF THIS PLAN AND PROFILE SHALL BE RESPONSIBLE FOR OBTAINING ALL NECESSARY PERMITS AND FOR THE ACCURACY OF THE DATA.

SCALE: 1" = 40'
SCALE: 1" = 40'
DRAWN BY: GA
CHECKED BY: S4/DB
DATE: 03-10-08



Stanley Consultants INC.
3600 N. Tenth Avenue, Suite 700
Tucson, Arizona 85710
(520) 790-0900
www.stanleyconsultants.com

RHODES HOMES ARIZONA, LLC
GOLDEN VALLEY RANCH
AREA 2 PHASE A
F STREET PLAN AND PROFILE
MOHAVE COUNTY ARIZONA

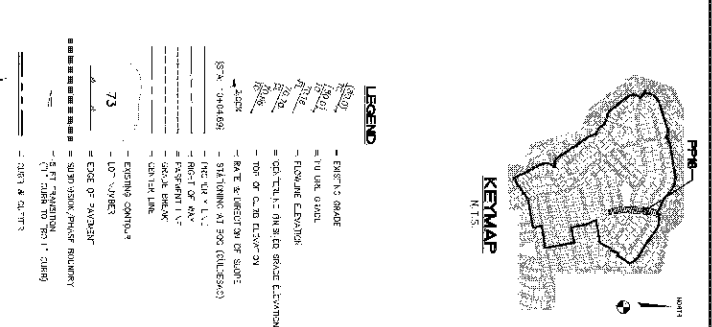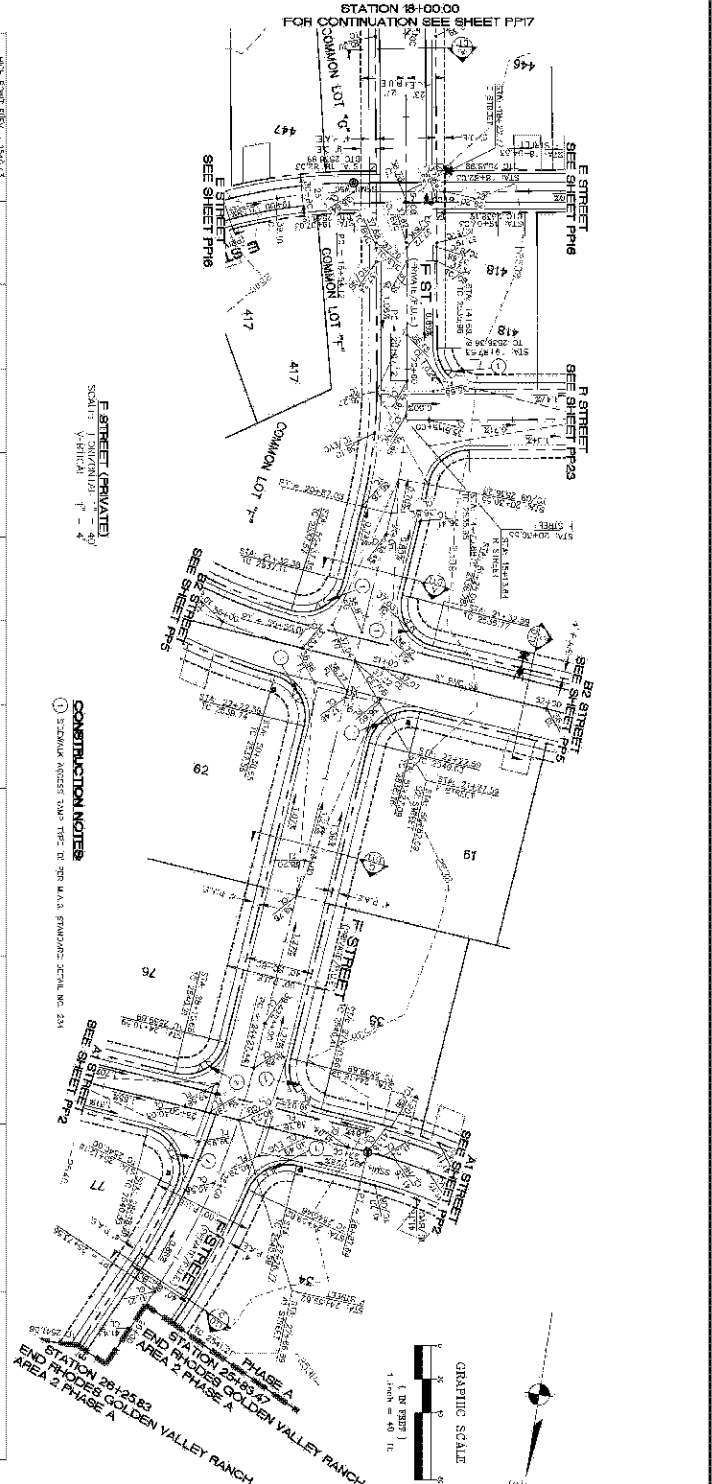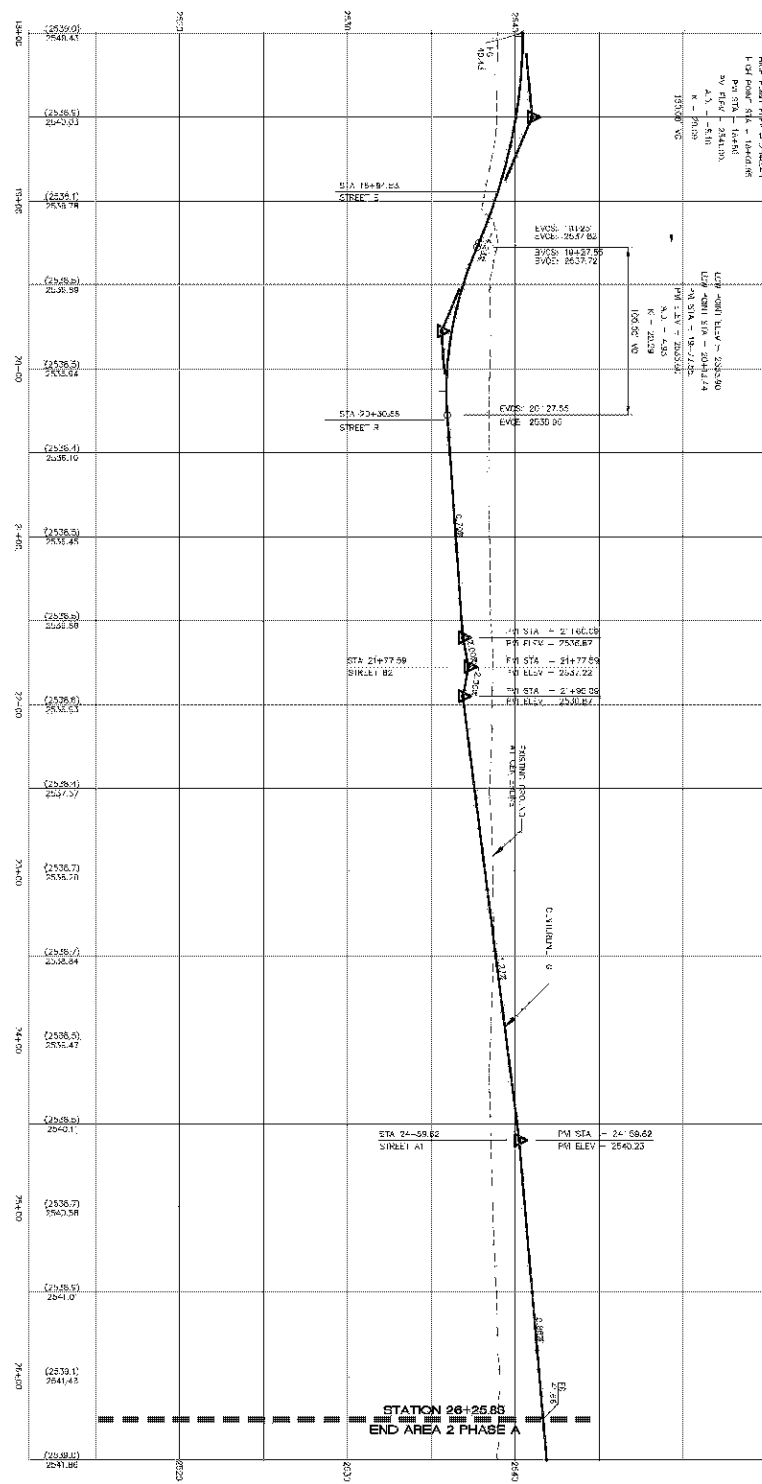

DISCLAIMER NOTE
THESE PLANS AND SPECIFICATIONS ARE PRELIMINARY AND NOT FOR CONSTRUCTION. THE ENGINEER ASSUMES NO LIABILITY FOR ANY ERRORS OR OMISSIONS. THE USER OF THESE PLANS AND SPECIFICATIONS SHALL BE RESPONSIBLE FOR OBTAINING ALL NECESSARY PERMITS AND APPROVALS FROM THE APPROPRIATE AGENCIES. THE ENGINEER'S RESPONSIBILITY IS LIMITED TO THE DESIGN AND CONSTRUCTION OF THE PROJECT AS SHOWN ON THESE PLANS AND SPECIFICATIONS. THE ENGINEER DOES NOT WARRANT THE ACCURACY OR COMPLETENESS OF THE INFORMATION PROVIDED HEREON. THE USER OF THESE PLANS AND SPECIFICATIONS SHALL BE RESPONSIBLE FOR OBTAINING ALL NECESSARY PERMITS AND APPROVALS FROM THE APPROPRIATE AGENCIES. THE ENGINEER'S RESPONSIBILITY IS LIMITED TO THE DESIGN AND CONSTRUCTION OF THE PROJECT AS SHOWN ON THESE PLANS AND SPECIFICATIONS. THE ENGINEER DOES NOT WARRANT THE ACCURACY OR COMPLETENESS OF THE INFORMATION PROVIDED HEREON.


PRELIMINARY ISSUE - FOR REVIEW
NOT FOR CONSTRUCTION 03.10.08

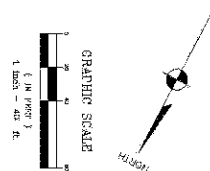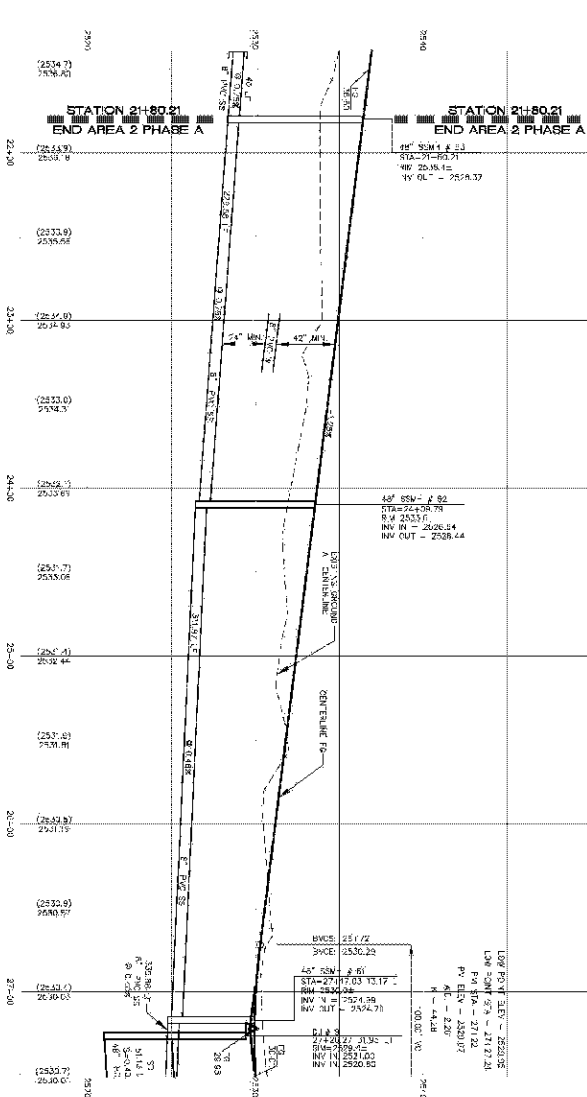

STREET (PRIVATE)
 S&M: 1 CTR/YNIA - 2 - 4C
 V-Hill: 1 - 4C


CONSTRUCTION NOTES:

① SIDEWALK ACCESS FAY, TYPE D PER M.A.S. STANDARD DETAIL NO. 234

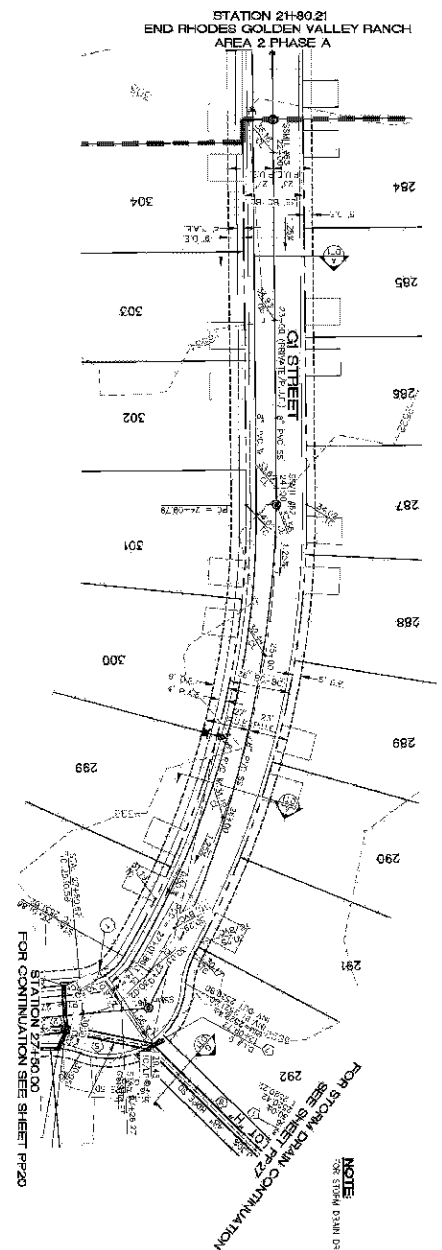

NOTE

NOTE:
FOR STORM DRAIN DROP INLET SECTIONS SEE SHEET D.7.7

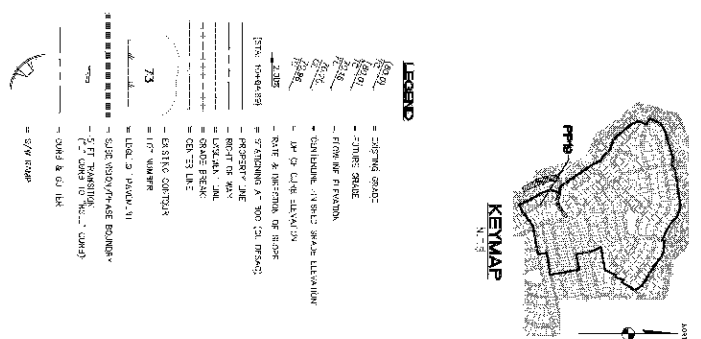

BASIS OF BEARING

[illegible]

08-000000

JUSTICE - 2009/2010: (N.A.W. 64)

DESCRIPTOR: ALUM CAP 2 IN. SE. 4 CONC. EU P.L. NOR HEAS
THE SCITE 1/2 CORNER OF SEC. 35, T. 21 N., R. 10 W. AND T. 2
INTERSECTION OF SEWARD DR AND HOPKINS RD. SHOWN "SU 54
R-2, 10343."

GEOTECHNICAL NOTES

ALONG WITH AN 8' X 10' SIGN WITH THE
SOLIS REPORT PRACTICE BY AMERICAN SOLIS
ENGINEER INC.
DATED: 2 SEPTEMBER 95
PROJECT No. 1069-020

FEMA FLOOD ZONE

P L A S - A - O - 4874 2. IT'S WITHIN AN AREA
 DESIGNATED AS A FLOOD ZONE "D", WHICH
 IS OUTSIDE THE AREA OF THE "D" YEAR STORM.

DISCLAIMER NOTE

LOCATIONING SYSTEMS ARE APPROXIMATE ONLY. IT SHALL BE THE CONTRACTOR'S RESPONSIBILITY TO OBTAIN THE EXACT HORIZONTAL AND VERTICAL LOCATION OF ALL EXISTING UTILITIES PRIOR TO CONSTRUCTION.

Call before you Dig
1-800-742-5348
(Outside N.J. add area code)

CALL US! AS THE
CONCRETE CONSTRUCTION
AND REPAIRS SPECIALISTS,
WE REPRESENT THE MOST
LARGE FIRM GROUPS IN THE
NAT. BLDG. INDUSTRY. I -
MR. STEVEN L. FORTNER, JR.,
MANAGER, EASTERN, U.S.
BRANCHES
FOR QUALITY AND AFFORDABLE
CONCRETE REPAIRS FOR ALL TYPES
OF BLDG. IN THE U.S.
KOD. 800/876-8111 OR 714/960-0000

**Call
before you
Overhead**

**Send request now
for details.**

1-828-755-4531
INFO 25

PRELIMINARY ISSUE - C? REVIEW
NOT FOR CONSTRUCTION 03 '0 06

RHODES HOMES ARIZONA, LLC
GOLDEN VALLEY RANCH

AREA 2 PHASE A
G1 STREET PLAN AND PROFILE AND
COUNTY OFFSITE STORM DRAIN

MOHAVE COUNTY OFFSITE STORM DRAIN ARIZONA

 3630 N. Eastern Avenue, Suite 700
Las Vegas, Nevada 89119
(702) 369-9386 Fax (702) 369-9795
www.stanecygroup.com

Stanley Consultants INC.

SCALE (-) 1"=40'
SCALE (+) 1"=4'
DRAWN BY GA
CHECKED BY SH/D
DATE 03-10-06

[illegible]